

ADJUSTABLE TRACER WIRE ACCESS BOX

1 PLACE BITUMINOUS MASTIC

2 FILL ANNULAR SPACE AROUND

PIPE WITH NON-SHRINK

GROUT INSIDE & OUT

8" MIN POURED OR -

PRECAST CONCRETE BASE

SCALE:NOT TO SCALE

COMPOUND BETWEEN SECTIONS

MAX 6

CONCRETE ADJUSTING

RINGS WITH NON-SHRINK

1/2" THICK INSIDE AND OUT

GROUT AND PLASTERED

REFER TO PLANS

FOR PIPE REQUIRED

REFER TO PLANS FOR

SLOPE 1" PER FT

CATCH BASIN DESIGN G

NOT TO SCALE

CATCH BASIN STRUCTURE DESIGN R-1 (2'x3')
NOT TO SCALE

CASTING REQUIRED

RON OLSON

ANDERSON

13605 1st Avenue N. #100

Plymouth, MN 55441 | ae-mn.com

P 763.412.4000 | **F** 763.412.4090

Anderson Engineering of Minnesota, LLC

THE VILLAGE AT

COLOGNE

18TH ADDITION

COLOGNE, MN 55322

I HEREBY CERTIFY THAT THIS PLAN, SPECIFICATION, OF REPORT WAS PREPARED BY ME OR UNDER MY DIRECT SUPERVISION AND THAT I AM A DULY LICENSED PROFESSIONAL ENGINEER UNDER THE LAWS OF THE STATE OF MINNESOTA.

PRINT NAME: LEE KOPPY, PE

NOT FOR CONSTRUCTION

DATE: <u>8/29/2025</u> LICENSE NO. <u>41267</u>

REVISION LOG

DESCRIPTION OF REVISIONS

FINAL PLAT 8/29/2025

DESIGNED: DRAWN: CHECKED BY: LRK CDN LRK

DRAWING TITLE

CIVIL DETAILS

DRAWING NO.


C11


COMM. NO. 18344

SANITARY SEWER MANHOLE SCALE:NTS

WITH TRACER WIRE ACCESS BOX SCALE:NTS

SANITARY SEWER SERVICE

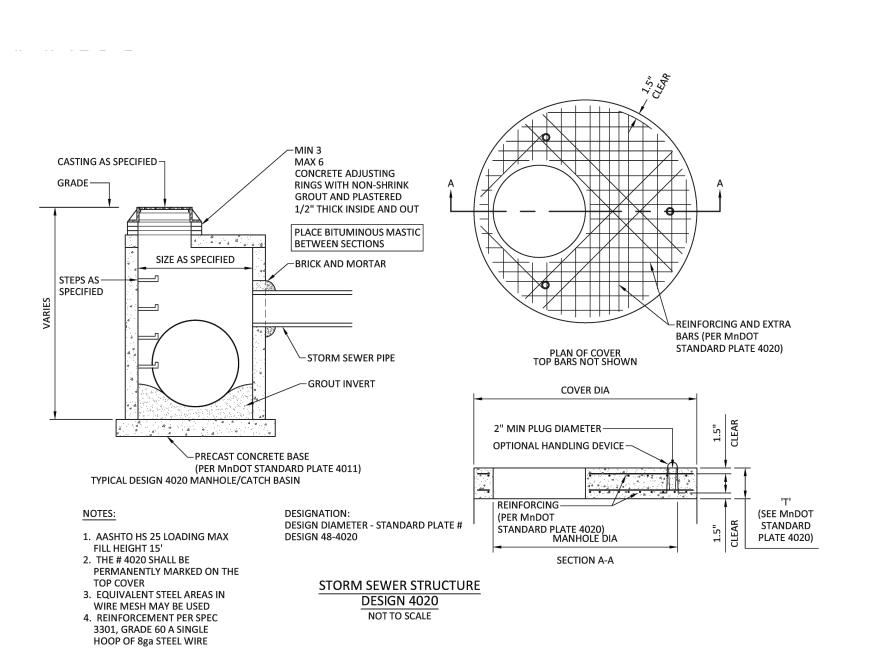

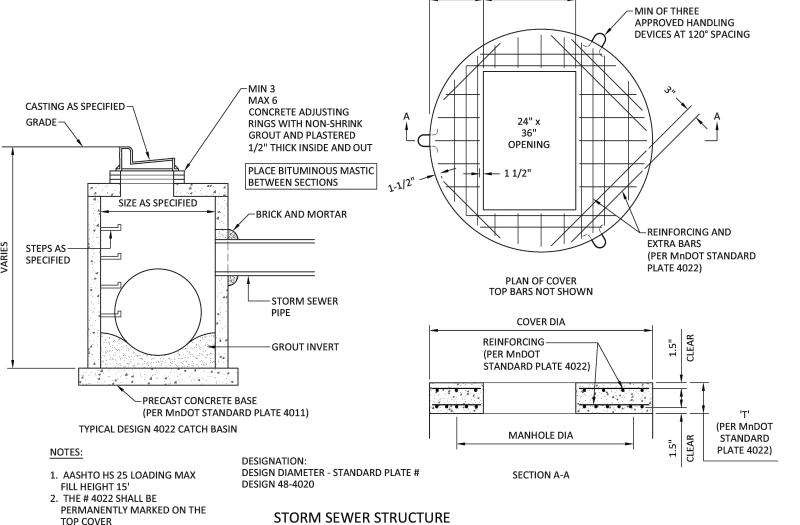



HOOP OF 8ga STEEL WIRE

STORM SEWER STRUCTURE (CBMH-301, 302, & 303)

CATCH BASIN PLAN BASE SLAB PLAN 1. CASTING PER CONSTRUCTION DOCUMENTS 2. PIPE CUT-OUTS PER CONSTRUCTION DOCUMENTS 3. ALTERNATE CAST-IN-PLACE BASE CAN BE USED 4. MIN REINFORCING SHALL BE WIRE FABRIC HAVING AN AREA OF NOT LESS THAN 0.12 SQ IN PER FOOT IN BOTH DIRECTIONS

CATCH BASIN (CB-202)

CATCH BASIN (CB-304) SCALE: NOT TO SCALE

STORM SEWER STRUCTURE (STMH-201 & CB-401) SCALE:NOT TO SCALE

COMPACTED BACKFILL

GRANULAR BORROW

MNDOT SPEC.

DIA = OUTSIDE DIAMETER OF PIPE

UNCOMPACTED MATERIAL.

** = BEDDING DIA/3 WIDE.

LOOSELY PLACED /

DIA+24" MIN.


WATERMAIN INSULATION


SCALE:NTS


PVC PIPE FOUNDATION & BEDDING IN GOOD SOILS


3149.2.B.1 MOD.


AUG. 29, 2025

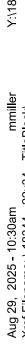


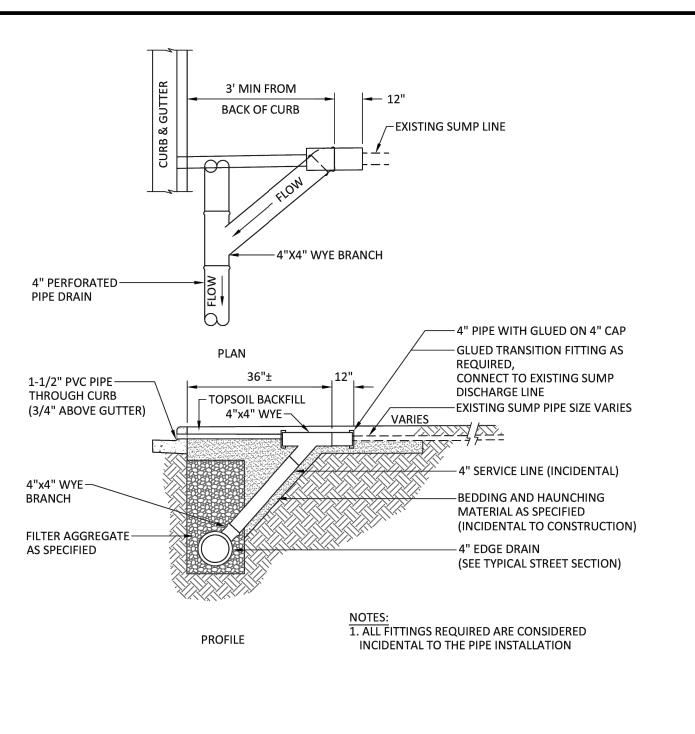

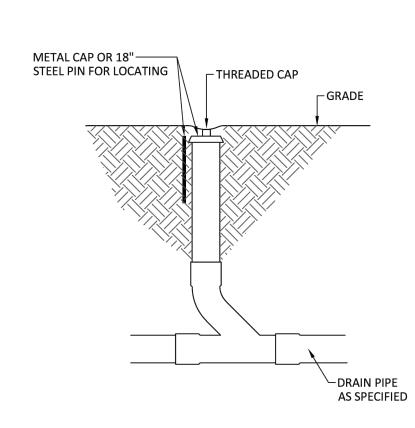

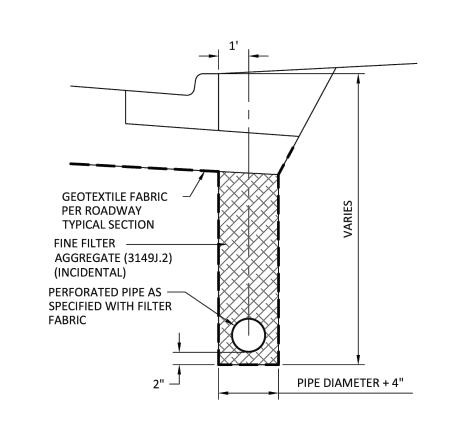

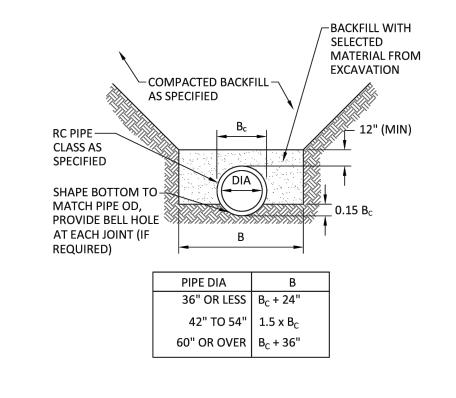

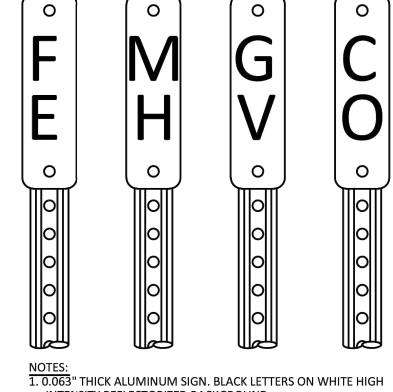

- INTENSITY REFLECTORIZED BACKGROUND.
- 2. U-CHANNEL POST, MINIMUM 3 LB/FT 6'-6" LONG, PAINTED GREEN.
- 3. PLACED AT ALL STRUCTURES IN GREEN SPACES, UNLESS OTHERWISE DIRECTED BY CITY.


STRUCTURE MARKER SIGNS


SUMP PUMP SERVICE CONNECTION








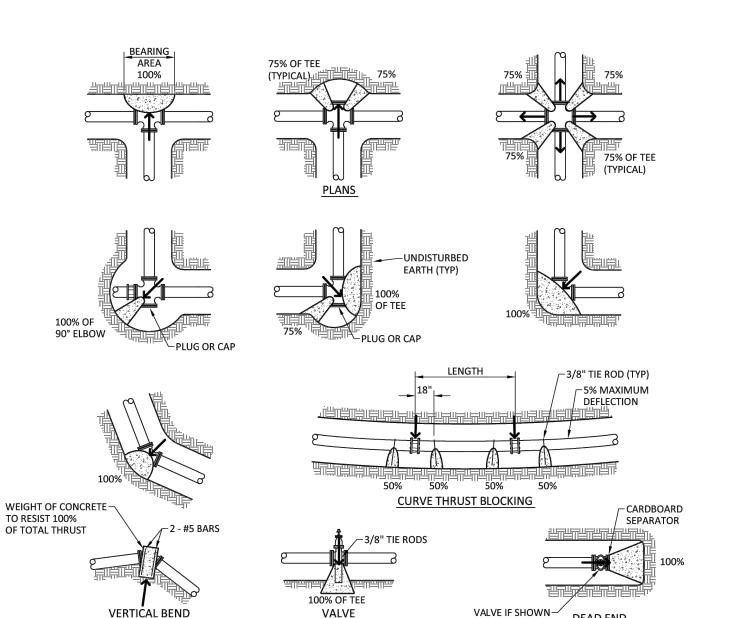


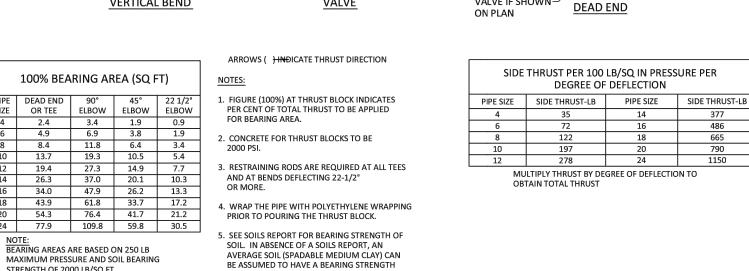



THRUST BLOCKS ARE NOT REQUIRED ON PVC WITH SOLVENT WELDED JOINTS.

CONCRETE THRUST BLOCKS

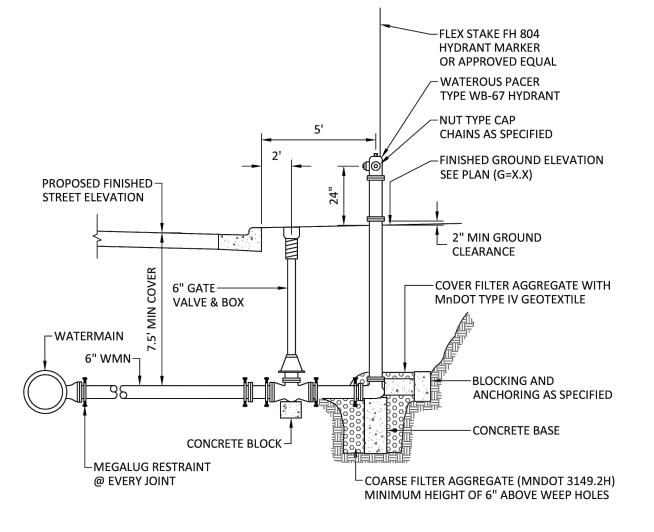

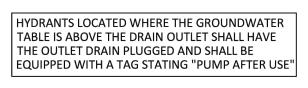

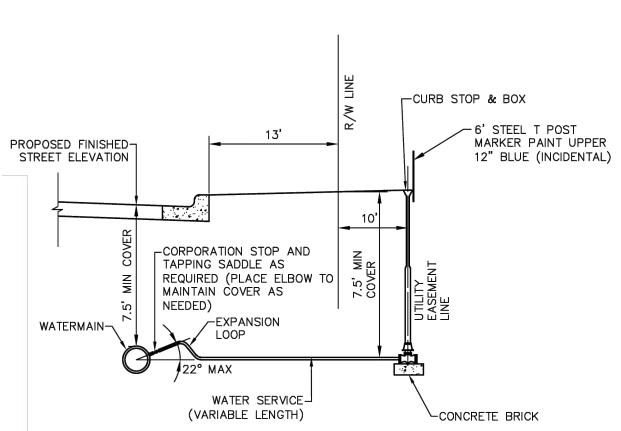

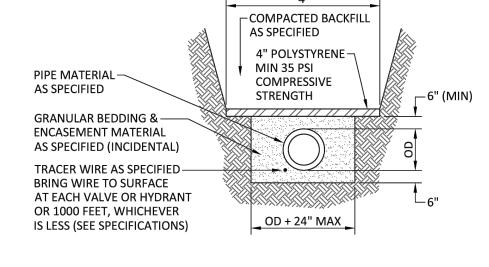

WATERMAIN INSULATION NOT TO SCALE

HYDRANT INSTALLATION MEGALUGS SCALE:NOT TO SCALE

WATER SERVICE INSTALLATION SCALE:NOT TO SCALE

WATERMAIN INSULATION SCALE: NOT TO SCALE

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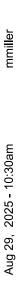
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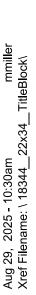
C12


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STRENGTH OF 2000 LB/SQ FT.

SCALE:NOT TO SCALE






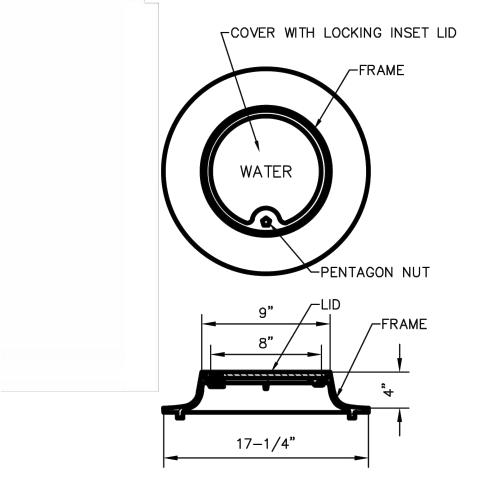

1. FURNISH AND INSTALL ON CURB STOPS THAT ARE WITHIN CONCRETE

CASTING ASSEMBLY - CURB STOP

OR BITUMINOUS SURFACING
2. CASTING ASSEMBLY TO BE FORD METER BOX MODEL A1 OR APPROVED

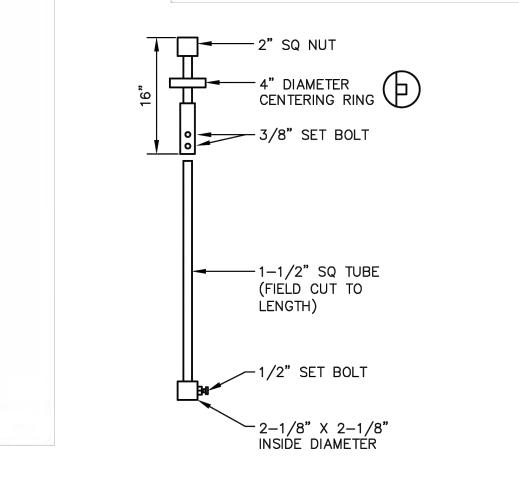


ADJUSTABLE VALVE EXTENSION STEM SCALE:NTS

COMPACTED BACKFILL GRANULAR MATERIAL MNDOT SPEC. 3149.2.B.1 DIA/24 BUT ** = BEDDING DIA/3 WIDE. NOT LESS THAN 3" DIA+24" MIN. LOOSELY PLACED / UNCOMPACTED MATERIAL. <u>INSTALLATION TYPE 1</u> DIA = OUTSIDE DIAMETER OF PIPE

COMPACTED BACKFILL GRANULAR MATERIAL + + + + + + + MNDOT SPEC. 3149.2.B.1 ** = BEDDING DIA/3 WIDE. DIA/24 BUT NOT LESS THAN 3" DIA+24" MIN. LOOSELY PLACED / UNCOMPACTED MATERIAL.

INSTALLATION TYPE 2 DIA = OUTSIDE DIAMETER OF PIPE

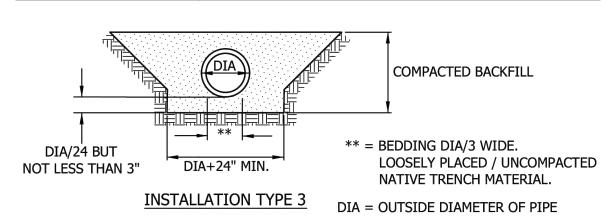

PIPE FOUNDATION & BEDDING METHODS FOR DIP SCALE: NOT TO SCALE

VALVE BOX SETTING TO-BE 1/2 " BELOW BASE OR WEAR COURSE AND AT GRADE IN TURF VALVE BOX TO BE SET-TO HAVE 6" ADJUSTMENT UP AND DOWN FROM FINISH GRADE VALVE BOX &-COVER AS SPECIFIED BOTTOM SECTION -BONNETT SHALL BE PLACED-HALFWAY BETWEEN TOP OF FLANGE AND BOLTS REQUIRED GATE-VALVE ADAPTER WATERMAIN-GATE VALVE-

GATE VALVE BOX INSTALLATION

SCALE: NOT TO SCALE

1. VALVE BOX SHALL BE CENTERED ON OPERATING NUTS, STRAIGHT, FREE FROM DEBRIS, AND ALL SECTIONS

2. VALVES IN EASEMENTS SHALL HAVE CHANNEL POST WITNESS MARKERS WITH REFLECTIVE "GV" SIGN

SCALE:NTS

3. DEEP VALVES SHALL HAVE NUT EXTENSIONS INSTALLED TO ELEVATION TO ACCOMMODATE STANDARD 10' KEY; BOTTOM NUT SHALL BE BOLTED TO VALVE NUT AND ONLY ONE 4. COMPACTION WITH MECHANICAL TAMPER AROUND VALVE BOX

SHALL BE PLACED AND COMPACTED WITH 2' LIFTS TO ACHIEVE 95% COMPACTION

5. GATE VALVES LOCATED WITHIN THE CONCRETE SIDEWALK SHALL INCLUDE A METAL SEPARATOR BETWEEN THE VALVE BOX AND THE CONCRETE

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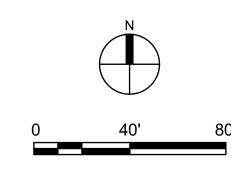
CIVIL DETAILS

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C13

COMM. NO. AUG. 29, 2025 18344





LEGEND

PROPERTY LIMITS CONSTRUCTION LIMITS **EXISTING MINOR CONTOUR** EXISTING MAJOR CONTOUR PROPOSED MINOR CONTOUR PROPOSED MAJOR CONTOUR **EXISTING WOODLAND PERIMETER** SOD

NOTES

- 1. PER CITY OF COLOGNE, IRRIGATION IS NOT REQUIRED.
- 2. IF A DISCREPANCY IS FOUND, THE PLANTING PLAN SHALL OVERRIDE THE PLANT SCHEDULE.
- 3. SEE CIVIL FOR EROSION CONTROL BLANKET LOCATIONS.

PLANT SCHEDULE

| SYMBOL | CODE | <u>QTY</u> | COMMON / BOTANICAL NAME | <u>CONT</u> | CAL |
|---|----------|------------|--|-------------|---------------|
| DECIDUOL | JS TREES | <u>S</u> | | | |
| | Aa | 3 | AUTUMN BLAZE® FREEMAN MAPLE ACER X FREEMANII 'JEFFERSRED' | B&B | 2 - 1/2" CAL. |
| | Gi | 5 | SKYLINE® HONEY LOCUST GLEDITSIA TRIACANTHOS INERMIS 'SKYCOLE' | B&B | 2 - 1/2" CAL. |
| | Tb | 4 | BOULEVARD AMERICAN LINDEN TILIA AMERICANA 'BOULEVARD' | B&B | 2 - 1/2" CAL. |
| EVERGRE | EN TREE | <u>:S</u> | | | |
| 000000000000000000000000000000000000000 | Pb | 6 | BLACK HILLS SPRUCE PICEA GLAUCA DENSATA | B&B | 6` HT. |

GENERAL SODDING & TOPSOIL NOTES:

- LANDSCAPE CONTRACTOR SHALL ENSURE THAT NEW TREES MOVED ONTO THE SITE ARE DUG FROM SIMILAR SITES WITH SIMILAR SOILS TO THE SOILS OF THIS PROJECT (HEAVY TO HEAVY, LIGHT TO LIGHT. HEAVY TO LIGHT SOILS). CONTRACTOR SHALL REVIEW SOIL CONDITIONS/TYPES WITH OWNER/LANDSCAPE ARCHITECT PRIOR TO INSTALLATION.
- ALL NEWLY INSTALLED PLANT MATERIAL SHALL BE PLANTED IN WELL-DRAINED AREAS. NOTIFY THE LANDSCAPE ARCHITECT PRIOR TO INSTALLATION IF ANY PLANT MATERIAL IS LOCATED IN DRAINAGE SWALES OR WET & POORLY DRAINED AREAS.
- ALL PLANTINGS SHALL RECEIVE FERTILIZER AS FOLLOWS:
- 3.1. SUMMER AND FALL PLANTING: 0-20-20 GRANULAR (IN SAUCER AROUND PLANT AT THE RATE OF 12 OZ. PER 2-3" CAL. TREE & 6 OZ. PER SHRUB).
- 3.2. SPRING PLANTING: 10-10-10 GRANULAR (APPLY ABOVE REFERENCED FERTILIZER AT A RATE OF 12 OZ. PER 1-1/2" CAL. TREE OR LARGER & 6 OZ. PER SHRUB & PERENNIAL.
- 4. ALL PLANTINGS SHALL RECEIVE AN AMENDED SOIL MIX CONSISTING OF THREE (3) PARTS:
- 4.1. 45% APPROVED TOPSOIL (ONE SITE PREFERRED)
- 4.2. 45% ORGANIC MATTER (TYPE 1 SPHAGNUM PEAT MOSS FINELY DIVIDED WITH A PH OF 3.1 - 5.0.)
- 4.3. 10% SAND (FINE CLEAN MASONRY SAND)
- AREAS TO RECEIVE SOD SHALL HAVE A 6" MINIMUM DEPTH OF TOPSOIL. TOPSOIL SHALL PROVIDE FERTILE, FRIABLE, NATURAL LOAM, SURFACE SOIL, REASONABLY FREE OF SUBSOIL, CLAY CLUMPS, BRUSH WEEDS AND OTHER LITTER, AND FREE OF ROOTS, STUMPS, STONE LARGER THAN 1" IN ANY DIMENSION, AND OTHER EXTRANEOUS OR TOXIC MATTER HARMFUL TO PLANT GROWTH.
- SOD SHALL BE 30" X 100' ROLLS WHERE APPLICABLE, TO BE LAID PARALLEL WITH THE CONTOURS AND HAVE STAGGERED JOINTS. ON SLOPES STEEPER THAN 3:1 OR DRAINAGE SWALES, THE SOD SHALL BE STAKED INTO THE GROUND. SCARIFY THE EXISTING GRADES WITH FIELD CULTIVATOR PRIOR TO PLACING OF TOPSOIL AND FINISH GRADING FOR SOD. IMMEDIATELY PRIOR TO PLACING SOD, CONTRACTOR SHALL APPLY 10-6-4 FERTILIZER AT THE RATE OF 10 POUNDS PER 1000 SQ. FT.



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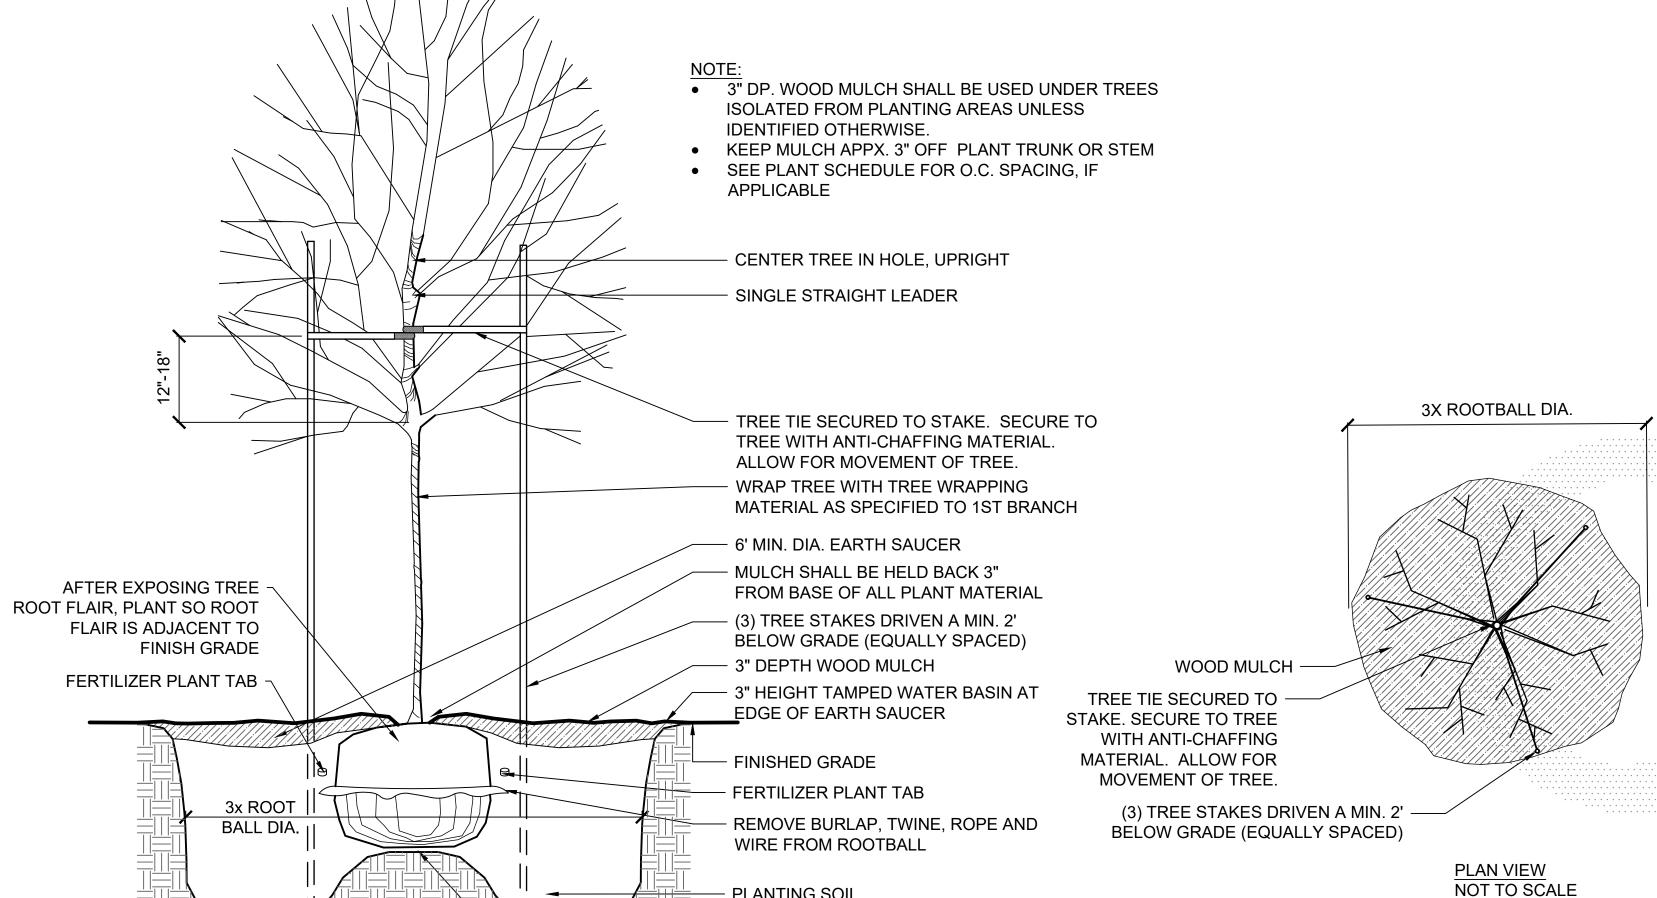
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DRAWING TITLE

LANDSCAPE PLAN

DRAWING NO.

COMM. NO. PLOTTED: AUG. 29, 2025 18344



PLANTING SOIL

MOUND MIN. 12"

DECIDUOUS TREE PLANTING DETAIL

SCALE: N.T.S.

UNDISTURBED OR COMPACTED SOIL

GENERAL LANDSCAPE NOTES:

- 1. LANDSCAPE CONTRACTOR SHALL VISIT THE PROJECT SITE PRIOR TO SUBMITTING A BID TO BECOME COMPLETELY FAMILIAR WITH SITE CONDITIONS.
- 2. ALL ROUGH AND FINISH GRADING TO BE DONE BY OTHERS.
- 3. NO PLANTING SHALL BE INSTALLED UNTIL ALL GRADING, BUILDING, CONSTRUCTION, UTILITY WORK & IRRIGATION (IF APPLICABLE) HAS BEEN COMPLETED IN THE AREAS TO BE PLANTED.
- 4. IT IS THE RESPONSIBILITY OF THE CONTRACTOR TO IDENTIFY ALL UNDERGROUND CABLES. CONDUITS. WIRES. ETC.. ON THE PROPERTY.
- 5. IF THERE IS A DISCREPANCY BETWEEN THE NUMBER OF PLANTS SHOWN ON THE PLAN AND THE NUMBER OF PLANTS SHOWN IN THE PLANT LIST, THE NUMBER OF PLANTS SHOWN ON THE PLAN WILL TAKE PRECEDENCE.
- 6. ALL PROPOSED PLANT MATERIAL SHALL BE LOCATED CAREFULLY AS SHOWN ON THE PLAN. IF THE CONTRACTOR BELIEVES AN ERROR HAS BEEN MADE REGARDING SPACING OR LOCATION OF THE PLANT MATERIAL INDICATED ON THE PLAN, NOTIFY THE LANDSCAPE ARCHITECT PRIOR TO INSTALLATION.
- 7. THE CONTRACTOR IS RESPONSIBLE FOR COMPLETE MAINTENANCE OF THE PLANT MATERIAL (WATERING, SPRAYING, FERTILIZING, MOWING, ETC.) UNTIL THE WORK HAS BEEN ACCEPTED, BY THE OWNER.
- THE CONTRACTOR IS RESPONSIBLE FOR ALL REPAIRS TO PROPERTY DAMAGE FROM PLANTING OPERATIONS AT NO COST TO THE OWNER.
- 9. ALL NEWLY PLANTED PLANT MATERIAL SHALL BE GUARANTEED THROUGH ONE CALENDAR YEAR STARTING FROM THE DATE OF ACCEPTANCE ESTABLISHED BY THE OWNER.
- 10. THE CONTRACTOR SHALL MEET WITH THE OWNER OR OWNERS REPRESENTATIVE ON SITE WHEN THEY FEEL THE PROJECT IS COMPLETE ACCORDING TO THE CONTRACT DOCUMENTS. IF ALL WORK IS SATISFACTORY AND COMPLETE ACCORDING TO THE CONDITIONS OF THE CONTRACT DOCUMENTS, THEN THE OWNER MUST DECLARE THE PROJECT COMPLETE. THIS DECLARATION WILL CONSTITUTE AS THE BEGINNING OF THE ONE (1) YEAR WARRANTEE PERIOD FOR ALL PLANT MATERIAL. THE OWNER SHALL PROVIDE A LETTER WITH SIGNATURE STATING THE DATE OF ACCEPTANCE.
- 11. WIND BURN OR OTHERWISE DAMAGED PLANT MATERIAL WILL NOT BE ACCEPTED
- 12. THE PRACTICE OF STAKING SHOULD NOT ALLOW NAILS, SCREWS, WIRES, ETC. TO PENETRATE THE OUTER SURFACE OF THE TREES.
- 13. THE CONTRACTOR WILL BE RESPONSIBLE FOR THE REMOVAL OF ALL TREE STAKES, GUYS, STRAPS AND TRUNK PROTECTION MEASURES FOLLOWING THE COMPLETION OF THE WARRANTEE PERIOD OR AS DIRECTED BY THE OWNER.
- 14. LANDSCAPE CONTRACTOR IS REQUIRED TO PROVIDE THE OWNER WITH MAINTENANCE INFORMATION DURING THE GUARANTEE PERIOD RELATING TO WATERING, FERTILIZING, PRUNING, PEST CONTROL, AND RELATED ITEMS. THIS WILL BE PREPARED AND DELIVERED TO THE OWNER AFTER PROVISIONAL INSPECTION APPROVAL HAS BEEN GIVEN BY THE OWNER AND/OR LANDSCAPE ARCHITECT.
- 15. INSTALL CORRUGATED PLASTIC TREE GUARDS. WHITE IN COLOR. WITH THE SIZE OF TUBE 1" DIA. (MIN.) LARGER THAN THE CALIPER OF THE TREE TO BE PROTECTED.
- 16. 3" DEPTH SHREDDED HARDWOOD MULCH SHALL BE INSTALLED UNDER ALL TREES AND SHRUBS THAT ARE ISOLATED FROM GROUNDCOVER AREAS AND GENERAL SHRUB MASSES
- 17. CALIPER OF TREES UP TO AND INCLUDING 4" SHALL BE MEASURED AT 6" ABOVE GROUND LEVEL AND 12" ABOVE GROUND LEVEL FOR LARGER SIZES.
- 18. FOR BALLED & BURLAP PLANT MATERIAL, REMOVE THE TOP HALF OF THE BURLAP FROM THE ROOT BALL. WIRE CAGES, STRAPS, ETC. SHALL BE REMOVED FROM THE TOP HALF OF THE ROOTBALL BEFORE INSTALLATION.
- 19. LANDSCAPE CONTRACTOR SHALL PROVIDE AND INSTALL NURSERY GROWN PLANT MATERIAL CONFORMING TO THE REQUIREMENTS AND RECOMMENDATIONS OF THE LATEST EDITION OF ANSI Z60.1 STANDARDS UNLESS OTHERWISE NOTED IN THE PLANS OR SPECIFICATIONS.

GENERAL PLANT ESTABLISHMENT PERIOD NOTES:

- THE REQUIRED WORK SHALL CONSIST OF CONTINUOUSLY CONDUCTING OPERATIONS AND MAINTENANCE FOR A WARRANTY PERIOD ESTABLISHED FOR 1 YEAR AFTER THE INSTALLATION HAS BEEN ACCEPTANCE BY THE OWNER. THE WORK INCLUDES
- 11.1. ESTABLISHMENT OF BALLED AND BURLAPPED AND SODDED AREAS
- INCLUDING PEST CONTROL, FERTILIZING AND FUNGICIDAL TREATMENTS
- 1.3. REGULAR WATERING SCHEDULED FOR ALL PLANT MATERIAL AND SOD
- 1.4. REMOVAL OF ALL WEEDS WITHIN THE PROJECT AREA BY METHODS AGREED BY THE OWNER (POST/PRE HERBICIDE TREATMENT, HAND OR MECHANICAL REMOVAL)
- MAINTENANCE OF MISCELLANEOUS ITEMS (EROSION CONTROL PRODUCTS, REPAIRS FROM
- 2. THE CONTRACTOR SHALL BE RESPONSIBLE FOR ON-SITE REVIEW MEETINGS WITH THE OWNER DURING THE PLANT ESTABLISHMENT PERIOD TO IDENTIFY OPERATIONS AND MAINTENANCE TO BE EXECUTED MONTHLY.
- 3. PLANT MATERIAL DEEMED TO BE REPLACED AT THE END OF PLANT ESTABLISHMENT PERIOD SHALL BE EXECUTED WITHIN 2 WEEKS (14 DAYS) PRESENTING LESS THE FOLLOWING SURVIVORSHIP:
- 3.1. BALLED AND BURLAPPED PLANT MATERIAL: 75%
- 3.2. SODDED AREAS: 100% (0% BARE SOIL)
- 4. REPLACEMENT PLANTS AND SOD SHALL BE OF THE SAME SPECIES AND SIZE AS ORIGINALLY SPECIFIED ON THE DRAWINGS, UNLESS THE OWNER DETERMINES THAT SUBSTITUTIONS OF ANOTHER SPECIES OR SIZE SHALL BE MADE.



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