## PRELIMINARY PLAT

## THE VILLAGE AT COLOGNE, 18TH ADDITION

COLOGNE, MN



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ANDERSON

13605 1st Avenue N. #100

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## THE VILLAGE AT COLOGNE 18TH ADDITION

COLOGNE, MN 55322

**RON OLSON** 

I HEREBY CERTIFY THAT THIS PLAN, SPECIFICATION, OR REPORT WAS PREPARED BY ME OR UNDER MY DIRECT SUPERVISION AND THAT I AM A DULY LICENSED PROFESSIONAL ENGINEER UNDER THE LAWS OF THE STATE OF MINNESOTA.

PRINT NAME: <u>LEE KOPPY, PE</u>

SIGNATURE: NOT FOR CONSTRUCTION

DATE: <u>7/3/2025</u> LICENSE NO. \_4

**REVISION LOG** 

PRELIMINARY PLAT

7/3/2025

DESIGNED: DRAWN: CHECKED BY:
LRK CDN LRK

DRAWING TITLE

**COVER SHEET** 

DRAWING NO.


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PLOTTED: JULY 3, 2025


COMM. NO. 18344

CALL 48 HOURS BEFORE DIGGING
Utilities Underground Location Center
DIAL 811

State
Know what's below,
before you dig.

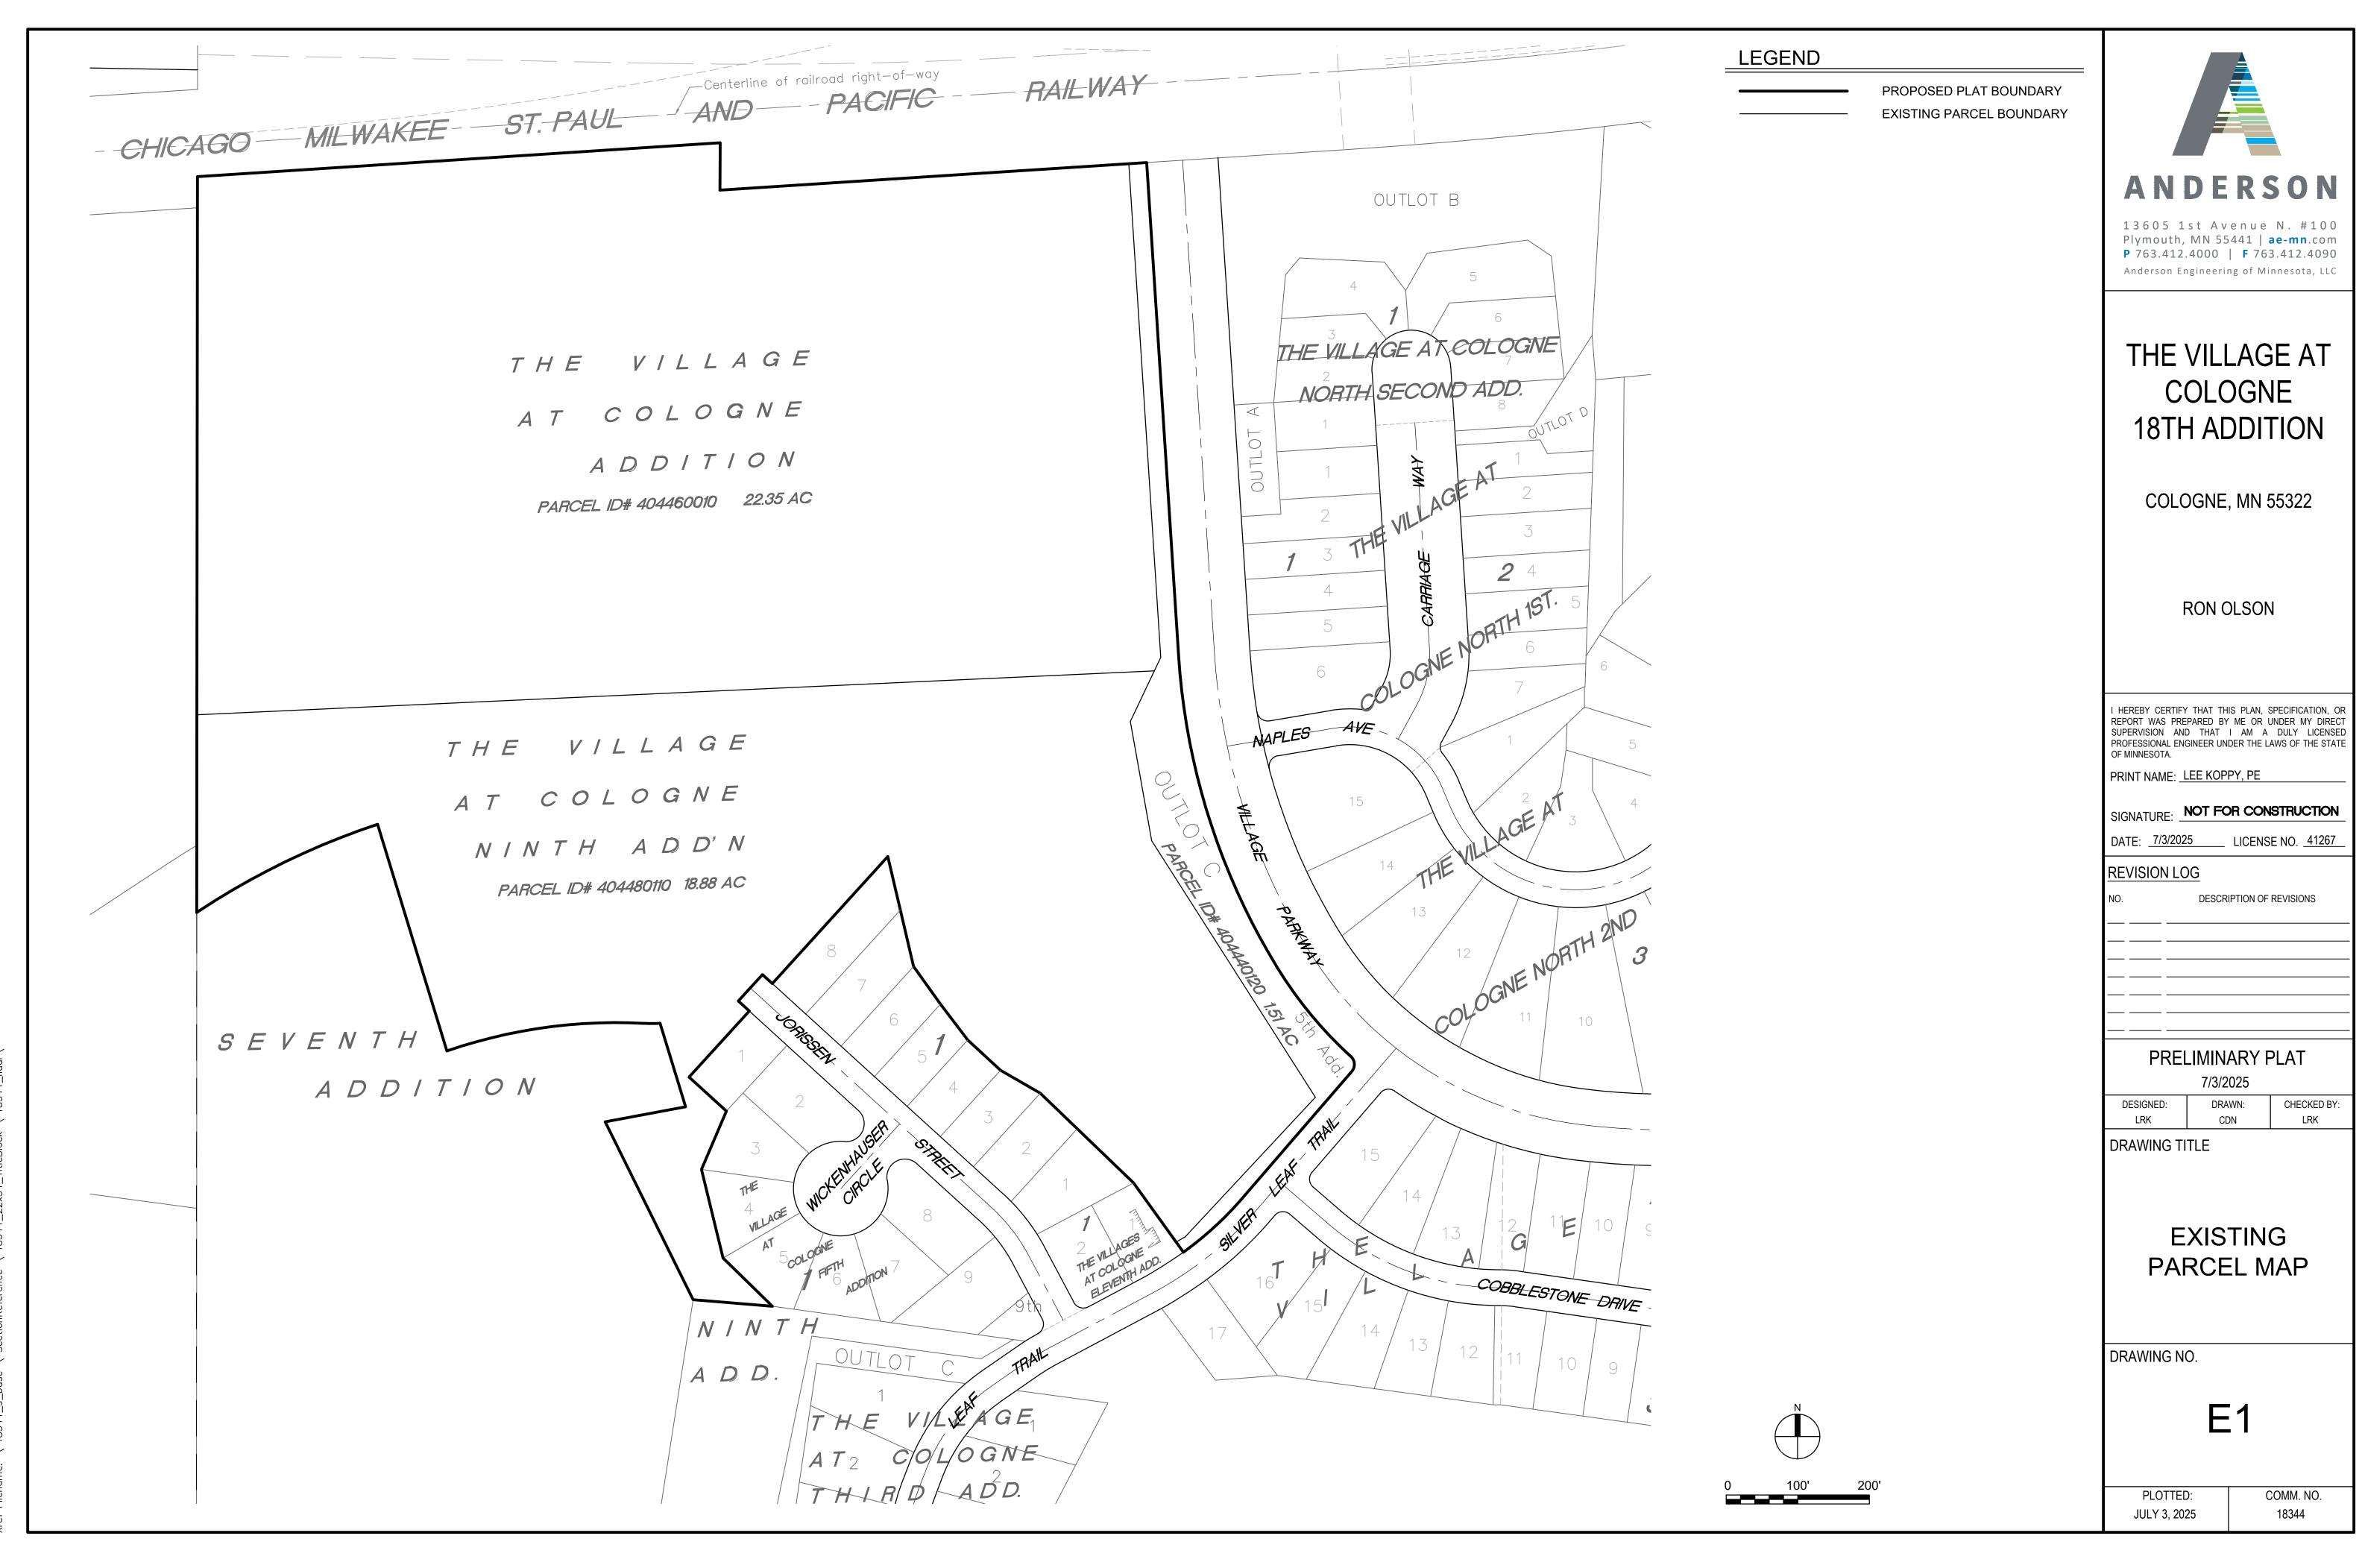



2025 — 12:01pm — clichty — Y: \18300\18344 ron olson — residential — cologne mn\\_07 civil\\_01 cad files\\_01 SHEETS\ gme: \ 18344 s hase \ SectionBeference \ 18344 22×34 TitleBlack \ 18344 Iidar\

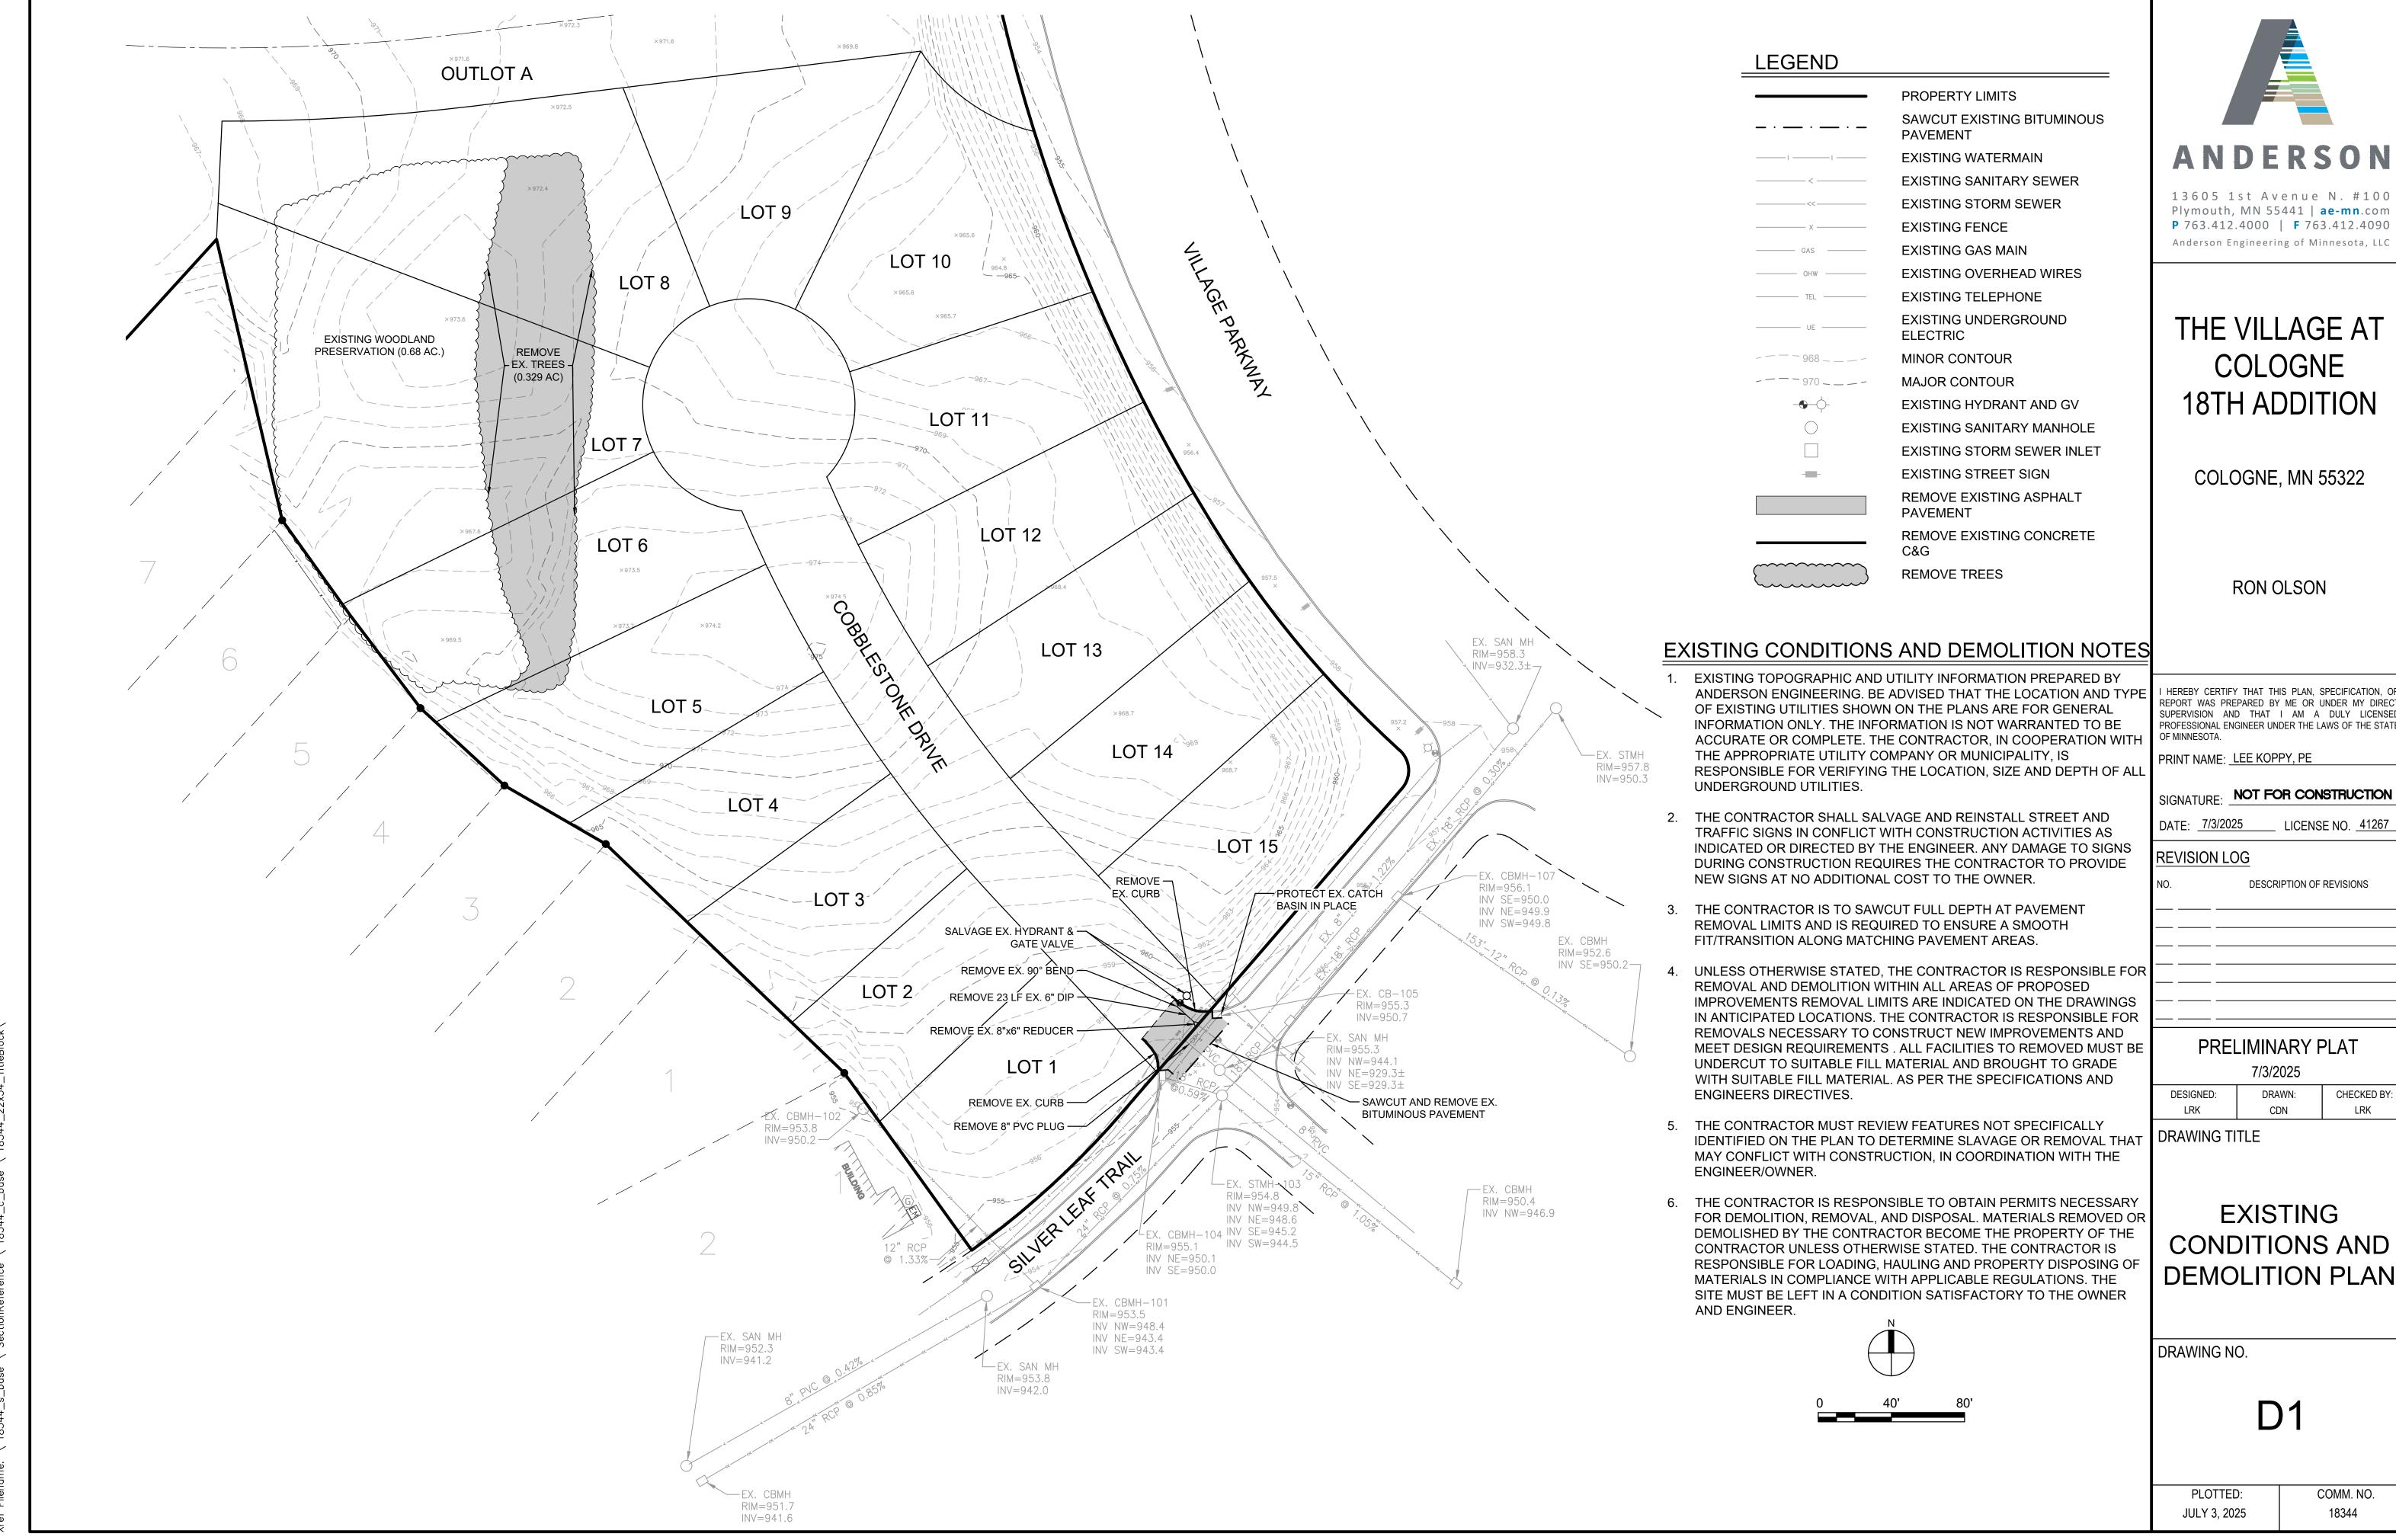

ANDERSON

SUPERVISION AND THAT I AM A DULY LICENSEI PROFESSIONAL ENGINEER UNDER THE LAWS OF THE STATE

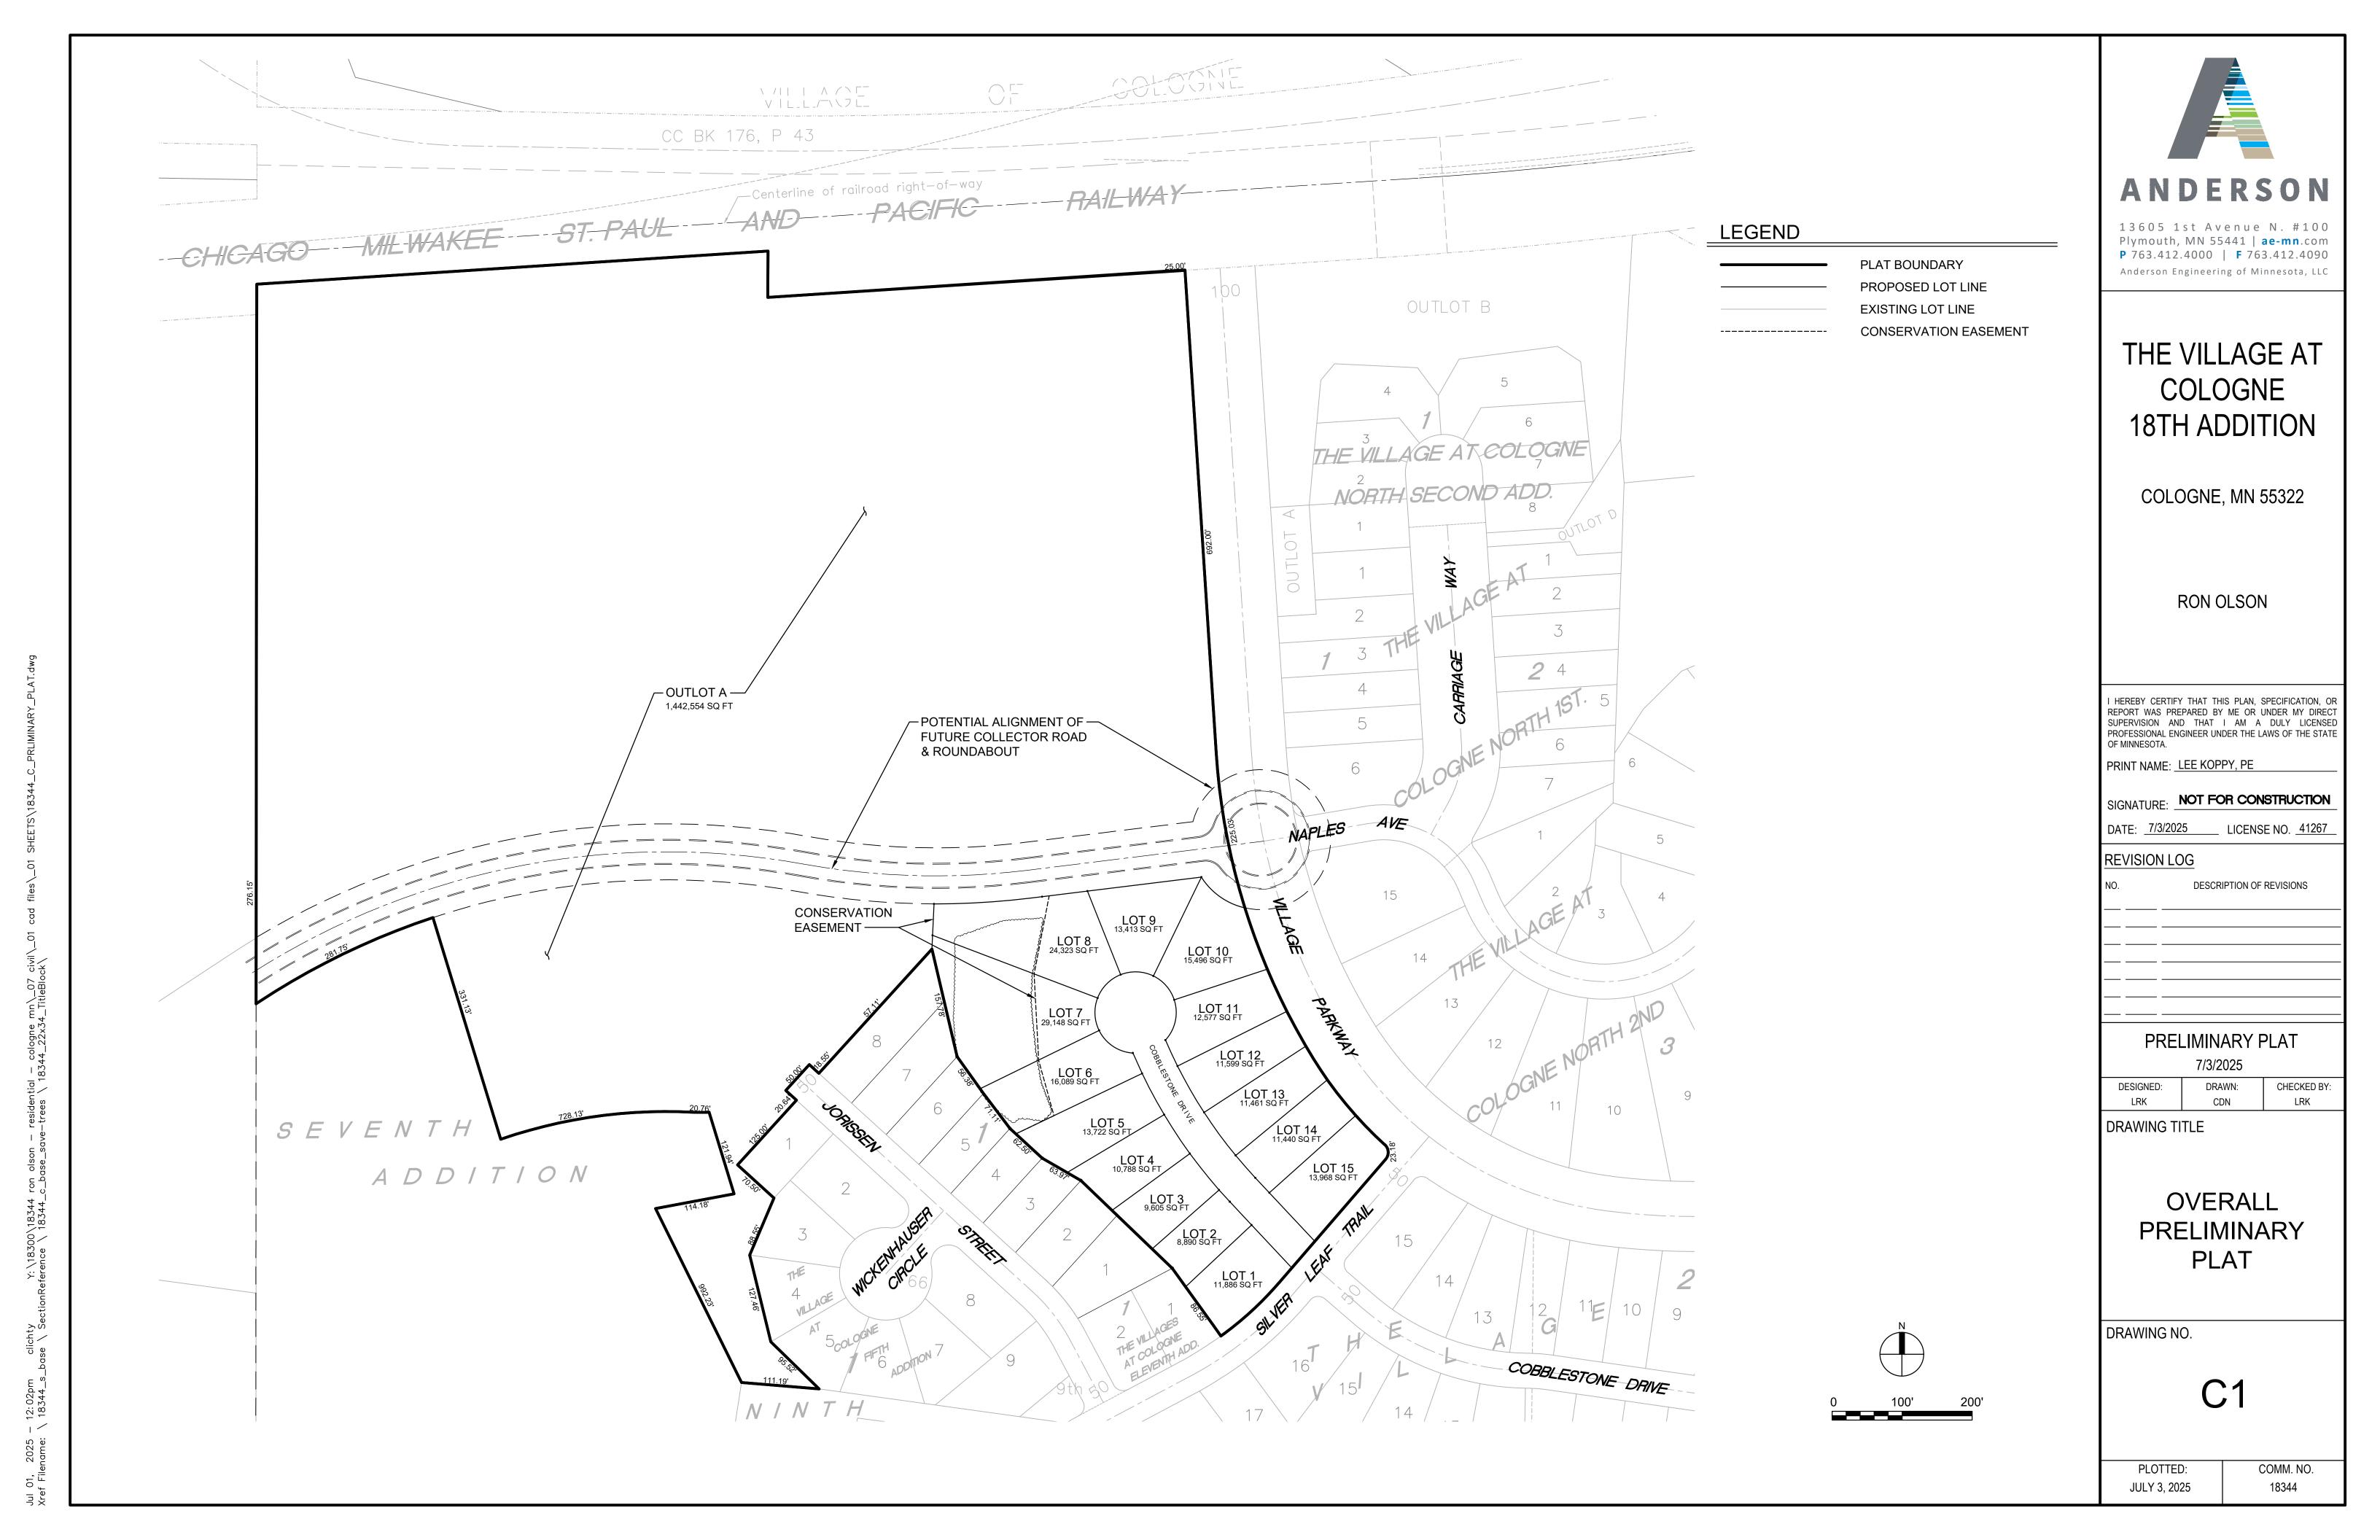

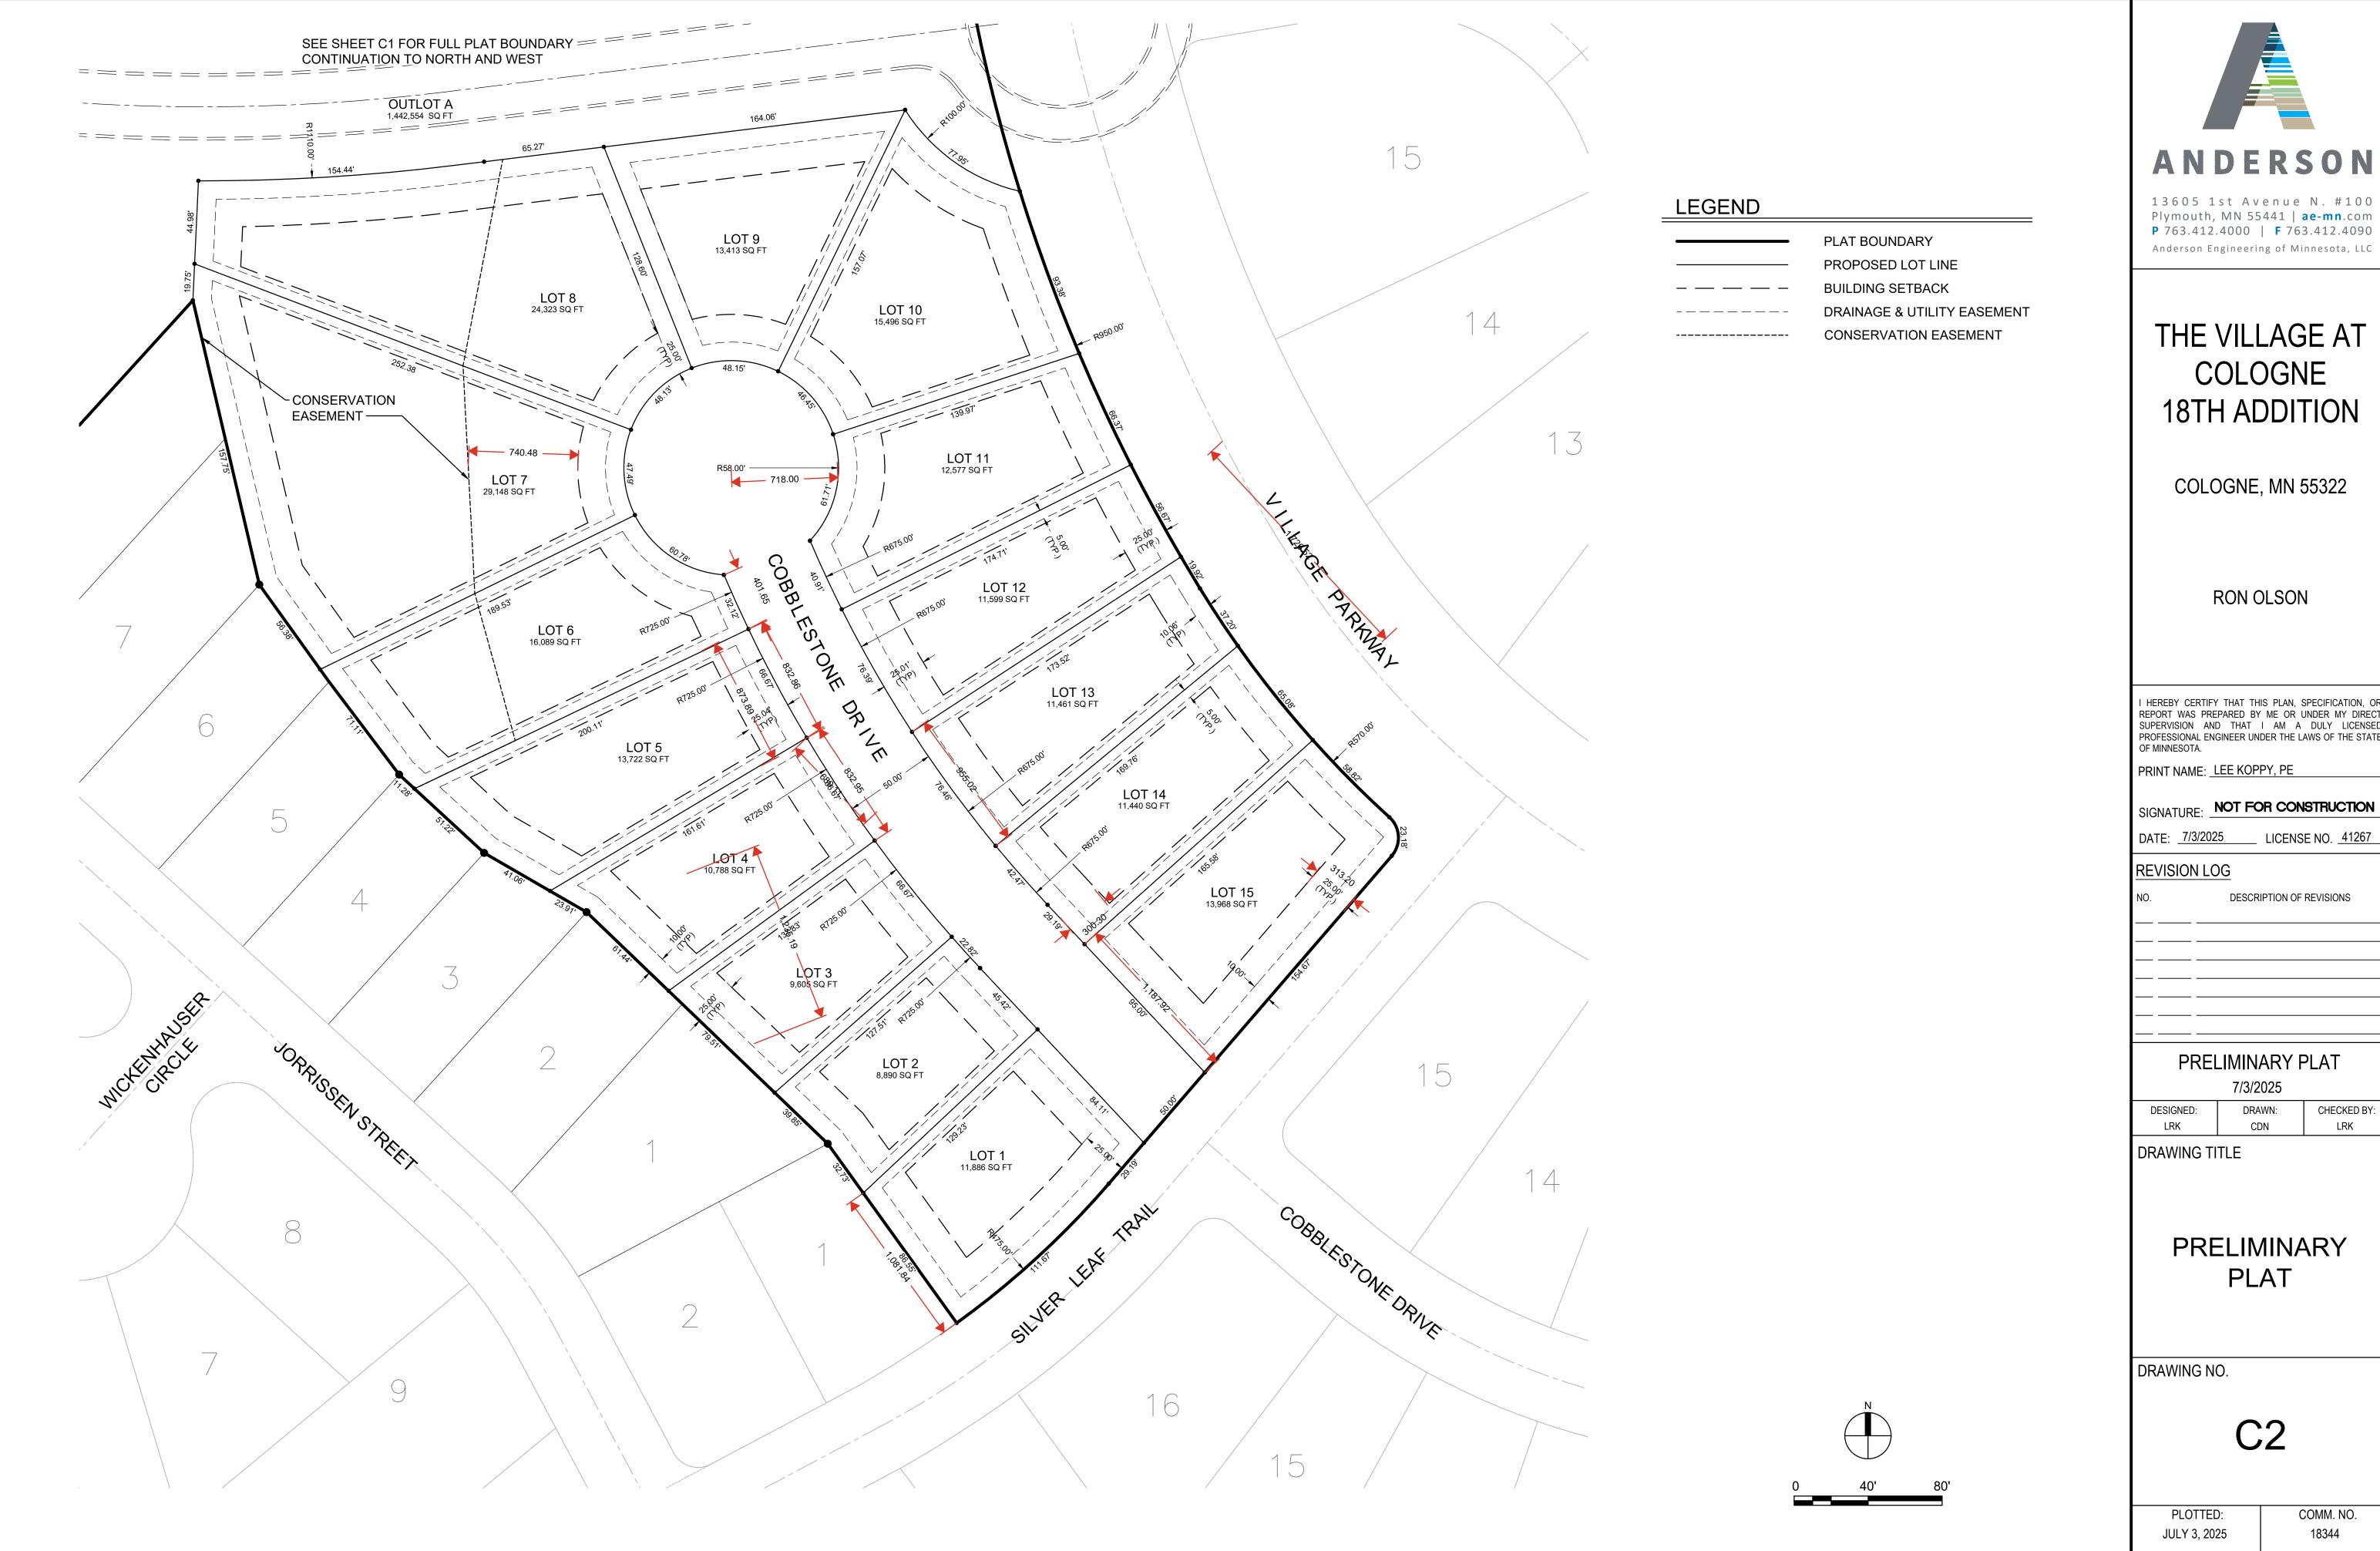

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## THE VILLAGE AT COLOGNE **18TH ADDITION**

COLOGNE, MN 55322


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7/3/2025

CHECKED BY: LRK

PLAT



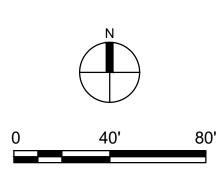

## LEGEND

PROPERTY LIMITS

ADJACENT PROPERTY

BUILDING SETBACKS

DRAINAGE AND UTILITY
EASEMENT

CONSERVATION EASEMENT
PROPOSED CONCRETE C&G
PROPOSED BITUMINOUS
PAVEMENT

## IMPERVIOUS AREA

PAVEMENT & CURBS 19,077 SF

DRIVEWAYS 10,648 SF

HOMES 31,905 SF (15 x 2,127 SF)

TOTAL 61,630 SF



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PRINT NAME: LEE KOPPY, PE

SIGNATURE: NOT FOR CONSTRUCTION

DATE: <u>7/3/2025</u> LICENSE NO. <u>41267</u>

REVISION LOG

PRELIMINARY PLAT 7/3/2025

DESIGNED: DRAWN:

DRAWING TITLE

SITE PLAN

DRAWING NO.


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PLOTTED: JULY 3, 2025

COMM. NO. 18344

CHECKED BY: LRK



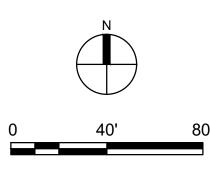

## LEGEND

	PROPERTY LIMITS
<u> </u>	CONSTRUCTION LIMITS
—  —	EXISTING MINOR CONTOUR
—  —	EXISTING MAJOR CONTOUR
966 ———	PROPOSED MINOR CONTOUR
965 ———	PROPOSED MAJOR CONTOUR
»	PROPOSED STORM SEWER
	PROPOSED DRAINTILE
× 959.4	EXISTING SPOT ELEVATION
$\bullet_{B-1}$	SOIL BORING LOCATION
$\Longrightarrow$	DRAINAGE ARROW
	PROPOSED RETAINING WALL
	PROPOSED CONCRETE C&G
	TIP OUT CURB
SF	SILT FENCE
$\circ$	INLET SEDIMENT PROTECTION
	ROCK CONSTRUCTION ENTRANCE
<b>×</b> 800.1	SPOT ELEVATION



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REVISION LOG

O. DESCRIPTION OF REVISIONS

PRELIMINARY PLAT

7/3/2025

DESIGNED: DRAWN:

CDN

DRAWING TITLE

GRADING &
EROSION
CONTROL PLAN

DRAWING NO.

C

PLOTTED: JULY 3, 2025

COMM. NO. 18344

CHECKED BY: LRK

#### THE PLANNED SCOPE OF THE PROJECT INCLUDES:

- THE INSTALLATION OF EROSION CONTROL MEASURES AS REQUIRED FOR THE MASS GRADING OF THE SITE FOR THE CONSTRUCTION OF 16 RESIDENTIAL LOTS.
- GRADING AS REQUIRED FOR THE INSTALLATION OF THE STRUCTURES, BUILDINGS AND ROADS.
- THE CONSTRUCTION OF A STORMWATER POND
- INSTALLATION OF SANITARY SEWER, WATERMAIN, AND STORM SEWER.
- PLACEMENT OF CONCRETE AS REQUIRED TO ESTABLISH CURB, GUTTER, AND SIDEWALKS THROUGHOUT THE SITE.
- CONSTRUCTION OF RESIDENTIAL BUILDINGS

#### RECEIVING WATERS

THESE WATERS ARE LOCATED WITHIN ONE MILE (AERIAL RADIUS) OF THE PROJECT LIMITS AND RECEIVE RUNOFF FROM THE PROJECT SITE. DUE TO THE PROXIMITY OF THE RECEIVING WATERS, THE BMPS DESCRIBED IN APPENDIX A OF THE NPDES PERMIT MAY APPLY TO ALL AREAS OF THE SITE.



WATERS WITHIN 1 MILE RADIUS					
NAME OF WATER BODY	TYPE (LAKE, RIVER, WETLAND, DITCH, ETC)	APPENDIX A SPECIAL WATER (YES OR NO)	IMPAIRED WATER WITHIN 1 MILE OF PROJECT SITE (YES OR NO)	APPROVED TMDL	RECEIVING WATERS (YES OR NO)
BENTON LAKE	LAKE	NO	YES	NA	NO
BEVENS CREEK	RIVER	NO	YES	NA	NO
MEUWISSEN LAKE	LAKE	NO	NO	NA	NO

## **SOIL TYPES**

SOIL TYPES TYPICALLY FOUND ON THIS PROJECT RANGE FROM LOAM TO CLAY LOAM AND HYDROLOGIC GROUP C TO D. PER WEB SOIL SURVEY IS TO BE KEPT ON SITE AS PART OF THE SWPPP AND IS TO BE MADE AVAILABLE UPON REQUEST.

## LONG TERM MAINTENANCE AND OPERATION

RON OLSON CONSTRUCTION HAS ENTERED INTO A MAINTENANCE AGREEMENT WITH THE CITY OF COLOGNE THAT IDENTIFIES THE AGENCY THAT IS RESPONSIBLE FOR ONGOING MAINTENANCE, AND HOW RESPONSIBILITY WILL BE TRANSFERRED TO OTHER AGENTS.

## PROJECT PERSONNEL AND TRAINING

THIS SWPPP WAS PREPARED BY PERSONNEL THAT ARE CERTIFIED IN THE DESIGN OF CONSTRUCTION SWPPP. COPIES OF THE CERTIFICATIONS ARE ON FILE WITH THE ENGINEER.

PROVIDE A CERTIFIED EROSION CONTROL SUPERVISOR IN GOOD STANDING WHO IS KNOWLEDGEABLE

AND EXPERIENCED IN THE APPLICATION OF EROSION PREVENTION AND SEDIMENT CONTROL BEST MANAGEMENT PRACTICES. THE EROSION CONTROL SUPERVISOR WILL WORK WITH THE PROJECT ENGINEER / SWPPP DESIGNER TO OVERSEE THE IMPLEMENTATION OF THE SWPPP AND THE INSTALLATION, INSPECTION, AND MAINTENANCE OF THE EROSION PREVENTION AND SEDIMENT CONTROL BMPS BEFORE, DURING, AND AFTER CONSTRUCTION UNTIL THE NOTICE OF TERMINATION (NOT) HAS BEEN FILED WITH THE MPCA. PROVIDE PROOF OF CERTIFICATION AT THE PRECONSTRUCTION MEETING. WORK WILL NOT BE ALLOWED TO COMMENCE UNTIL PROOF OF CERTIFICATION HAS BEEN PROVIDED TO THE PROJECT ENGINEER.

PROVIDE AT LEAST ONE CERTIFIED INSTALLER FOR EACH CONTRACTOR OR SUBCONTRACTOR THAT INSTALLS THE PRODUCTS. CERTIFIED INSTALLERS. PROVIDE PROOF OF CERTIFICATION AT THE PRECONSTRUCTION MEETING. WORK WILL NOT BE ALLOWED TO COMMENCE UNTIL PROOF OF CERTIFICATION HAS BEEN PROVIDED TO THE PROJECT ENGINEER.

#### CHAIN OF RESPONSIBILITY

THE OWNER AND CONTRACTOR ARE CO-PERMITTEES FOR THE NATIONAL POLLUTANT DISCHARGE ELIMINATION SYSTEM (NPDES) CONSTRUCTION PERMIT. THE CONTRACTOR IS RESPONSIBLE TO COMPLY WITH ALL ASPECTS OF THE NPDES CONSTRUCTION PERMIT AT ALL TIMES UNTIL THE NOTICE OF TERMINATION (NOT) HAS BEEN FILED WITH THE MPCA THE CONTRACTOR WILL DEVELOP A CHAIN OF COMMAND WITH ALL OPERATORS ON THE SITE TO ENSURE THAT THE SWPPP WILL BE IMPLEMENTED AND STAY IN EFFECT UNTIL THE CONSTRUCTION PROJECT IS COMPLETE, THE ENTIRE SITE HAS UNDERGONE FINAL STABILIZATION, AND A NOTICE OF TERMINATION (NOT) HAS BEEN SUBMITTED TO THE MPCA.

#### PROJECT CONTACTS

THE CONTRACTOR IS RESPONSIBLE FOR IMPLEMENTATION OF THE SWPPP AND INSTALLATION. INSPECTION, AND MAINTENANCE OF THE EROSION PREVENTION AND SEDIMENT CONTROL BMPS BEFORE. DURING, AND AFTER CONSTRUCTION UNTIL THE NOTICE OF TERMINATION (NOT) HAS BEEN FILED.

CONTACT INFORMATION			
ORGANIZATION CONTACT NAME PHONE			
RON OLSON CONSTRUCTION	RON OLSON	612-369-4240	
ANDERSON ENGINEERING (SWPPP DESIGN)	MATTIE MILLER*	763-412-4000	
[CONTRACTOR]	[CONTRACTOR NAME]	[#]	

\*CERTIFIED FOR DESIGN OF CONSTRUCTION SWPPP BY UNIVERSITY OF MINNESOTA. EXPIRES 2028 MPCA DUTY OFFICER 24 HOUR EMERGENCY NOTIFICATION: 651-649-5451 OR 800-422-0798

### SITE INSPECTION AND MAINTENANCE

CONTRACTOR SHALL PROVIDE NAME. CONTACT INFO. AND TRAINING DOCUMENTATION FOR THE PERSON RESPONSIBLE FOR SWPPP IMPLEMENTATION AND INSPECTION/MAINTENANCE OF BMPS.

INSPECT THE ENTIRE CONSTRUCTION SITE A MINIMUM OF ONCE EVERY SEVEN DAYS DURING ACTIVE CONSTRUCTION AND WITHIN 24 HOURS AFTER A RAINFALL EVENT GREATER THAN 0.5 INCHES WITHIN A 24 HOUR TIME FRAME. INSPECT ALL TEMPORARY AND PERMANENT WATER QUALITY MANAGEMENT, EROSION PREVENTION AND SEDIMENT CONTROL BMPS UNTIL THE SITE HAS UNDERGONE FINAL STABILIZATION AND THE N.O.T. HAS BEEN SUBMITTED. INSPECT SURFACE WATER INCLUDING DRAINAGE DITCHES FOR SIGNS OF EROSION AND SEDIMENT DEPOSITION. INSPECT CONSTRUCTION SITE VEHICLE EXIT LOCATIONS FOR EVIDENCE OF TRACKING ONTO PAVED SURFACES. INSPECT SURROUNDING PROPERTIES FOR EVIDENCE OF OFF SITE SEDIMENT ACCUMULATION.

RECORD ALL INSPECTIONS AND MAINTENANCE ACTIVITIES IN WRITING WITHIN 24 HOURS. SUBMIT INSPECTION REPORTS IN A FORMAT THAT IS ACCEPTABLE TO THE PROJECT ENGINEER.

FOR PROJECTS THAT DISCHARGE TO PROHIBITED WATERS, CONDUCT ROUTINE SITE INSPECTIONS AT A MINIMUM OF ONCE EVERY 72 HOURS (3 DAYS).

INCLUDE THE FOLLOWING IN THE RECORDS OF EACH INSPECTION AND MAINTENANCE ACTIVITY:

- A. DATE AND TIME OF INSPECTIONS
- B. NAME OF PERSONS CONDUCTING INSPECTIONS
- C. FINDINGS OF INSPECTIONS, INCLUDING RECOMMENDATIONS FOR CORRECTIVE ACTIONS D. CORRECTIVE ACTION TAKEN, INCLUDING DATES, TIMES, AND PARTY COMPLETING MAINTENANCE
- E. DATE AND AMOUNT OF ALL RAINFALL EVENTS GREATER THAN 0.5 INCH IN 24 HOURS
- F. DOCUMENTS AND CHANGES MADE TO THE SWPPP

## REPLACE, REPAIR OR SUPPLEMENT ALL NONFUNCTIONAL BMPS IN THE TIME PROVIDED BELOW:

- A. REPAIR, REPLACE, OR SUPPLEMENT PERIMETER CONTROL DEVICES WHEN IT BECOMES NONFUNCTIONAL OR SEDIMENT REACHES ½ THE HEIGHT OF THE DEVICE. COMPLETE REPAIRS BY THE END OF THE NEXT BUSINESS DAY FOLLOWING DISCOVERY.
- B. REPAIR OR REPLACE INLET PROTECTION DEVICES WHEN THEY BECOME NONFUNCTIONAL OR SEDIMENT REACHES ½ THE HEIGHT AND/OR DEPTH OF THE DEVICE. COMPLETE REPAIRS BY THE END OF THE NEXT BUSINESS DAY FOLLOWING DISCOVERY.
- C. DRAIN AND REMOVE SEDIMENT FROM TEMPORARY AND PERMANENT SEDIMENT BASINS ONCE THE SEDIMENT HAS REACHED  $\frac{1}{2}$  THE STORAGE VOLUME. COMPLETE WORK WITHIN 72 HOURS OF
- D. REMOVE ALL DELTAS AND SEDIMENT DEPOSITED IN SURFACE WATER INCLUDING DRAINAGE WAYS, CATCH BASINS, AND OTHER DRAINAGE SYSTEMS. RESTABILIZE ANY AREAS THAT ARE DISTURBED BY SEDIMENT REMOVAL OPERATION. SEDIMENT REMOVAL AND STABILIZATION MUST BE COMPLETED WITHIN 7 DAYS OF DISCOVERY. PREPARE AND SUBMIT A SITE MANAGEMENT PLAN FOR WORKING IN SURFACE WATERS.
- E. REMOVE TRACKED SEDIMENT FROM PAVED SURFACES BOTH ON AND OFF SITE WITHIN 24 HOURS OF DISCOVERY. STREET SWEEPING MAY HAVE TO OCCUR MORE OFTEN TO MINIMIZE OFF SITE IMPACTS. LIGHTLY WET THE PAVEMENT PRIOR TO SWEEPING.

F. MAINTAIN ALL BMPS UNTIL WORK HAS BEEN COMPLETED. SITE HAS GONE UNDER FINAL STABILIZATION, AND THE NOTICE OF TERMINATION (NOT) HAS BEEN SUBMITTED TO THE MPCA.

### AREA SUMMARY

ACREAGE SUMMARY	
AREA	ACRES
PROPERTY	5.59
DISTURBED	5.14
IMP. PRE-CONSTRUCTION	0.01
IMP. POST-CONSTRUCTION	1.43
NEW IMP.	1.42
PERVIOUS AT COMPLETION	4.06

#### SPECIAL SITE NOTES

IF SITE REQUIRES PERMANENT STORMWATER MANAGEMENT, HYDROLOGIC AND WATER QUALITY MODELING DATA IS AVAILABLE UPON REQUEST

THE SWPPP COORDINATOR MUST BE AVAILABLE FOR AN ONSITE INSPECTION WITHIN 72 HOURS UPON REQUEST BY THE MPCA AND SHALL BE RESPONSIBLE FOR THE FOLLOWING:

- SUBMIT THE NPDES PERMIT APPLICATION AND COMPLY WITH ALL REQUIREMENTS.
- OVERSEE INSTALLATION AND MAINTENANCE PRACTICES AND REPAIRS IDENTIFIED IN THE SWPPP.
- IMPLEMENT AND OVERSEE EMPLOYEE TRAINING AND RECORD IN OR WITH THE SWPPP.
- CONDUCT OR PROVIDE FOR INSPECTION AND MONITORING ACTIVITIES AND MAINTAIN LOGS AS PERMIT REQUIRES.
- IDENTIFY OTHER POTENTIAL POLLUTANT SOURCES NOT LISTED IN THE SWPPP AND ADD THEM.
- IDENTIFY ANY DEFICIENCIES IN THE SWPPP AND CORRECT THEM.
- ENSURE THAT CHANGES TO CONSTRUCTION PLANS ARE ADDRESSED IN THE SWPPP.
- FILE THE NOTICE OF TERMINATION UPON PROJECT COMPLETION.

AFTER THE NOTICE OF TERMINATION HAS BEEN FILED, THE OWNER SHALL BE RESPONSIBLE FOR ASSIGNING RESPONSIBILITY FOR PERMANENT MAINTENANCE MEASURES.

#### **PERMITS**

THE FOLLOWING PERMITS APPLY TO THIS PROJECT:

AGENCY	TYPE OF PERMIT	PERMIT # AND DATES
MINNESOTA POLLUTION CONTROL AGENCY (MPCA)	NPDES CONSTRUCTION PERMIT	[#]
CITY OF COLOGNE	GRADING PERMIT	[#]
CITY OF COLOGNE	BUILDING PERMIT	[#]

## LOCATION OF SWPPP REQUIREMENTS

THE REQUIRED SWPPP ELEMENTS MAY BE LOCATED IN MANY PLACES WITHIN THE PLAN SET.

## SWPPP AMENDMENTS

A QUALIFIED INDIVIDUAL MUST COMPLETE ALL SWPPP CHANGES. CHANGES INVOLVING THE USE OF A LESS STRINGENT BMP MUST INCLUDE A JUSTIFICATION DESCRIBING HOW THE REPLACEMENT BMP IS EFFECTIVE FOR THE SITE CHARACTERISTICS.

PERMITTEES MUST AMEND THE SWPPP TO INCLUDE ADDITIONAL OR MODIFIED BMPS AS NECESSARY TO CORRECT PROBLEMS IDENTIFIED OR ADDRESS SITUATIONS WHENEVER THERE IS A CHANGE IN DESIGN. CONSTRUCTION OPERATION, MAINTENANCE, WEATHER, OR SEASONAL CONDITIONS HAVING A SIGNIFICANT EFFECT ON THE DISCHARGE OF POLLUTANTS TO SURFACE WATERS OR GROUNDWATER.

PERMITTEES MUST AMEND THE SWPPP TO INCLUDE ADDITIONAL OR MODIFIED BMPS AS NECESSARY TO CORRECT PROBLEMS IDENTIFIED OR ADDRESS SITUATIONS WHENEVER INSPECTIONS OR INVESTIGATIONS BY THE SITE OWNER OR OPERATOR, USEPA OR MPCA OFFICIALS INDICATE THE SWPPP IS NOT EFFECTIVE IN ELIMINATING OR SIGNIFICANTLY MINIMIZING THE DISCHARGE OF POLLUTANTS TO SURFACE WATERS OR GROUNDWATER OR THE DISCHARGES ARE CAUSING WATER QUALITY STANDARD EXCEEDANCES OR THE SWPPP IS NOT CONSISTENT WITH THE OBJECTIVES OF A USEPA APPROVED TMDL



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## THE VILLAGE AT COLOGNE **18TH ADDITION**

COLOGNE, MN 55322

**RON OLSON** 

PROFESSIONAL ENGINEER UNDER THE LAWS OF THE STATE

PRINT NAME: LEE KOPPY, PE

NOT FOR CONSTRUCTION

LICENSE NO. 41267

REVISION LOG DESCRIPTION OF REVISIONS

> PRELIMINARY PLAT 7/3/2025

DESIGNED: DRAWN: CHECKED BY:

DRAWING TITLE

STORMWATER **POLLUTION PREVENTION** PLAN

DRAWING NO.

COMM. NO. JULY 3, 2025

ALL AREAS DISTURBED BY CONSTRUCTION WILL RECEIVE SEED OR SOD ACCORDING TO THE PLANS AND SPECIFICATIONS AND WITHIN THE SPECIFIED VEGETATIVE TIME SCHEDULE. FINAL STABILIZATION WILL OCCUR WHEN THE SITE HAS A UNIFORM VEGETATIVE COVER WITH A DENSITY OF 70% OVER THE ENTIRE DISTURBED AREA COMPARED TO EXISTING CONDITIONS. ALL TEMPORARY SYNTHETIC EROSION PREVENTION AND SEDIMENT CONTROL BMPS MUST BE REMOVED AS PART OF THE SITE FINAL STABILIZATION. ALL SEDIMENT MUST BE CLEANED OUT OF CONVEYANCES AND TEMPORARY SEDIMENTATION BASINS IF APPLICABLE.

AREA	TIME FRAME	NOTES
LAST 200 LINEAL FEET OF DRAINAGE DITCH OR SWALE	WITHIN 24 HOURS OF CONNECTION TO SURFACE WATER OR PROPERTY EDGE	1, 2, 3
REMAINING PORTIONS OF DRAINAGE DITCH OR SWALE	7 DAYS	1, 3
PIPE AND CULVERT OUTLETS	24 HOURS	
STOCKPILES	7 DAYS	1

- INITIATE INLET STABILIZATION IMMEDIATELY WHEN CONSTRUCTION HAS TEMPORARILY OR PERMANENTLY CEASED ON ANY PORTION OF THE SITE. COMPLETE STABILIZATION WITHIN THE TIME FRAME LISTED. IN MANY INSTANCES THIS WILL REQUIRE STABILIZATION TO OCCUR MORE THAN ONCE DURING THE COURSE OF THE PROJECT. TEMPORARY SOIL STOCKPILES WITHOUT SIGNIFICANT CLAY OR SILT AND STOCKPILED AND CONSTRUCTED ROAD BASE ARE NOT APPROPRIATE AND THEREFORE EXEMPT FROM THE STABILIZATION REQUIREMENT.
- APPLICATION OF MULCH, HYDROMULCH, TACKIFIER AND POLYACRYLAMIDE ARE NOT ACCEPTABLE STABILIZATION METHODS IN THESE AREAS.
- STABILIZE ALL AREAS OF THE SITE PRIOR TO THE ONSET OF WINTER, ANY WORK STILL BEING PERFORMED WILL BE SNOW MULCHED. SEEDED. AND BLANKETED WITHIN THE TIME FRAMES IN THE NPDES PERMIT
- 4. TOPSOIL BERMS MUST BE STABILIZED IN ORDER TO BE CONSIDERED PERIMETER CONTROL BMPS. USE RAPID STABILIZATION METHOD 2. 3. OR 4 AS DIRECTED BY THE ENGINEER. THE SEED MIX USED IN THE RAPID STABILIZATION MAY BE SUBSTITUTED AS FOLLOWS:
- SEED WITH OATS (O) A. SINGLE YEAR CONSTRUCTION BETWEEN MAY 1 & AUG. 1 SEED WITH WINTER WHEAT (WW) B. SINGLE YEAR CONSTRUCTION BETWEEN AUG. 1 & OCT. 31 C. MULTI YEAR CONSTRUCTION SEED WITH TWO-YEAR COVER CROP (TCC)
- 5. KEEP DITCHES AND EXPOSED SOILS IN AN EVEN ROUGH GRADED CONDITION IN ORDER TO BE ABLE TO APPLY EROSION CONTROL MULCHES. HYDROMULCHES AND BLANKETS.

## GENERAL SWPPP NOTES FOR CONSTRUCTION ACTIVITY

- CONTRACTOR SHALL AMEND THE SWPPP AND DOCUMENT ANY AND ALL CHANGES TO THE SWPPP AND ASSOCIATED PLAN SHEETS WITHIN 7 DAYS UPON IMPLEMENTATION. STORE THE SWPPP AND ALL AMENDMENTS ON SITE AT ALL TIMES.
- PREPARE AND SUBMIT A SITE MANAGEMENT PLAN FOR THE ENGINEER'S ACCEPTANCE FOR CONCRETE MANAGEMENT, CONCRETE SLURRY APPLICATION AREAS, WORK IN AND NEAR AREAS OF ENVIRONMENTAL SENSITIVITY. AREAS IDENTIFIED IN THE PLANS AS "SITE MANAGEMENT PLAN AREA". ANY WORK THAT WILL REQUIRE DEWATERING. AND AS REQUESTED BY THE ENGINEER. SUBMIT ALL SITE MANAGEMENT PLANS TO THE ENGINEER IN WRITING. ALLOW A MINIMUM OF 7 DAYS FOR THE ENGINEER TO REVIEW AND ACCEPT SITE MANAGEMENT PLAN SUBMITTALS. WORK WILL NOT BE ALLOWED TO COMMENCE IF A SITE MANAGEMENT PLAN IS REQUIRED UNTIL ACCEPTANCE HAS BEEN GRANTED BY THE ENGINEER. THERE WILL BE NO EXTRA TIME ADDED TO THE CONTRACT DUE TO THE UNTIMELY SUBMITTAL
- IT IS THE DESIGNER'S INTENT THAT THE CONTRACTOR BUILD PONDS AND INSTALL EROSION CONTROL BMPS BEFORE PUTTING THEM INTO ACTIVE SERVICE TO THE MAXIMUM EXTENT PRACTICABLE.
- BURNING OF ANY MATERIAL IS NOT ALLOWED WITHIN PROJECT BOUNDARY.
- DO NOT DISTURB AREAS OUTSIDE OF THE CONSTRUCTION LIMITS. DELINEATE AREAS NOT TO BE DISTURBED PRIOR TO STARTING GROUND DISTURBING ACTIVITIES. IF IT BECOMES NECESSARY TO DISTURB AREAS OUTSIDE OF THE CONSTRUCTION LIMITS. OBTAIN WRITTEN PERMISSION FROM THE PROJECT ENGINEER PRIOR TO PROCEEDING. PRESERVE ALL NATURAL BUFFERS SHOWN ON THE PLANS.
- ROUTE STORMWATER AROUND UNSTABILIZED AREAS OF THE SITE WHENEVER FEASIBLE. PROVIDE EROSION CONTROL AND VELOCITY DISSIPATION DEVICES AS NEEDED TO KEEP CHANNELS FROM ERODING AND TO PREVENT NUISANCE CONDITIONS AT THE OUTLET.
- DIRECT DISCHARGES FROM BMPS TO VEGETATED AREA WHENEVER FEASIBLE. PROVIDE VELOCITY DISSIPATION DEVICES AS NEEDED TO PREVENT EROSION.
- THE EROSION PREVENTION AND SEDIMENT CONTROL BMPS SHALL BE PLACED AS NECESSARY TO MINIMIZE EROSION FROM DISTURBED SURFACES AND TO CAPTURE SEDIMENT ON SITE. ALL EROSION CONTROL MEASURES SHALL BE IN PLACE PRIOR TO COMMENCEMENT OF ANY REMOVAL WORK AND/OR GROUND DISTURBING ACTIVITIES COMMENCE.
- ESTABLISH SEDIMENT CONTROL DEVICES ON ALL DOWN GRADIENT PERIMETERS AND UP GRADIENT OF ANY BUFFER ZONES BEFORE UP GRADIENT LAND DISTURBING ACTIVITIES BEGIN. MAINTAIN SEDIMENT CONTROL DEVICES UNTIL CONSTRUCTION IS COMPLETE AND THE SITE IS STABILIZED.
- 10. LOCATE PERIMETER CONTROL ON THE CONTOUR TO CAPTURE OVERLAND, LOW-VELOCITY SHEET FLOWS DOWN GRADIENT OF ALL EXPOSED SOILS AND PRIOR TO DISCHARGING TO SURFACE WATERS. PLACE J-HOOKS AT A MAXIMUM OF 100 FOOT INTERVALS.
- 11. PROVIDE PERIMETER CONTROL AROUND ALL STOCKPILES. PLACE BMP A MINIMUM 5 FEET FROM THE TOE OF SLOPE WHERE FEASIBLE. DO NOT PLACE STOCKPILES IN NATURAL BUFFER AREAS. SURFACE WATERS OR STORMWATER CONVEYANCES.
- 12. FLOATING SILT CURTAIN IS ALLOWED AS PERIMETER CONTROL FOR IN WATER WORK ONLY. INSTALL THE FLOATING SILT CURTAIN AS CLOSE TO SHORE AS POSSIBLE. PLACE PERIMETER CONTROL BMP ON LAND IMMEDIATELY AFTER THE IN WATER WORK IS COMPLETED.

- 13. DITCH CHECKS WILL BE PLACED AS INDICATED ON THE PLANS DURING ALL PHASES OF CONSTRUCTION
- 14. PLACE CONSTRUCTION EXITS, AS NECESSARY, TO PREVENT TRACKING OF SEDIMENT ONTO PAVED SURFACES BOTH ON AND OFF THE PROJECT SITE. PROVIDE CONSTRUCTION EXITS OF SUFFICIENT SIZE TO PREVENT TRACK OUT. MAINTAIN CONSTRUCTION EXITS WHEN EVIDENCE OF TRACKING IS DISCOVERED. REGULAR STREET SWEEPING IS NOT AN ACCEPTABLE ALTERNATIVE TO PROPER CONSTRUCTION EXIT INSTALLATION AND MAINTENANCE. CONSTRUCTION EXITS ARE INCIDENTAL
- 15. DISCHARGE TURBID OR SEDIMENT LADEN WATER TO TEMPORARY SEDIMENT BASINS WHENEVER FEASIBLE. IN THE EVENT THAT IT IS NOT FEASIBLE TO DISCHARGE THE SEDIMENT LADEN WATER TO A TEMPORARY SEDIMENT BASIN, THE WATER MUST BE TREATED SO THAT IT DOES NOT CAUSE A NUISANCE CONDITION IN THE RECEIVING WATERS OR TO DOWNSTREAM LANDOWNERS. CLEAN OUT ALL PERMANENT STORMWATER BASINS REGARDLESS OF WHETHER USED AS TEMPORARY SEDIMENT BASINS OR TEMPORARY SEDIMENT TRAPS TO THE DESIGN CAPACITY AFTER ALL UP GRADIENT LAND DISTURBING ACTIVITY IS COMPLETED.
- 16. PROVIDE SCOUR PROTECTION AT ANY OUTFALL OF DEWATERING ACTIVITIES.
- 17. PROVIDE STABILIZATION IN ANY TRENCHES CUT FOR DEWATERING OR SITE DRAINING PURPOSES.

#### POLLUTION PREVENTION

- 1. PROVIDE A SPILL KIT AT EACH WORK LOCATION ON THE SITE.
- STORE ALL BUILDING MATERIALS THAT HAVE THE POTENTIAL TO LEACH POLLUTANTS, PESTICIDES HERBICIDES, INSECTICIDES, FERTILIZERS, TREATMENT CHEMICALS, AND LANDSCAPE MATERIALS UNDER COVER WITH SECONDARY CONTAINMENT.
- PROVIDE A SECURE STORAGE AREA WITH RESTRICTED ACCESS FOR ALL HAZARDOUS MATERIALS. AND TOXIC WASTE. RETURN ALL HAZARDOUS MATERIALS AND TOXIC WASTE TO THE DESIGNATED STORAGE AREA AT THE END OF THE BUSINESS DAY UNLESS INFEASIBLE. STORE ALL HAZARDOUS MATERIALS AND TOXIC WASTE (INCLUDING BUT NOT LIMITED TO OIL, DIESEL FUEL, GASOLINE, HYDRAULIC FLUIDS, PAINT, PETROLEUM BASED PRODUCTS, WOOD PRESERVATIVES, ADDITIVES CURING COMPOUNDS, AND ACIDS) IN SEALED CONTAINERS WITH SECONDARY CONTAINMENT. CLEAN **UP SPILLS IMMEDIATELY**
- STORE, COLLECT AND DISPOSE OF ALL SOLID WASTE.
- POSITION ALL PORTABLE TOILETS SO THAT THEY ARE SECURE AND CANNOT BE TIPPED OR KNOCKED OVER. PROPERLY DISPOSE OF ALL SANITARY WASTE.
- 6. FUEL AND MAINTAIN VEHICLES IN A DESIGNATED CONTAINED AREA WHENEVER FEASIBLE. USE DRIP PANS OR ABSORBENT MATERIALS TO PREVENT SPILLS OR LEAKED CHEMICALS FROM DISCHARGING TO SURFACE WATER OR STORMWATER CONVEYANCES. PROVIDE A SPILL KIT AT EACH LOCATION THAT VEHICLES AND EQUIPMENT ARE FUELED OR MAINTAINED AT.
- LIMIT VEHICLE AND EQUIPMENT WASHING TO A DEFINED AREA OF THE SITE. CONTAIN RUNOFF FROM THE WASHING AREA TO A TEMPORARY SEDIMENT BASIN OR OTHER EFFECTIVE CONTROL. PROPERLY DISPOSE OF ALL WASTE GENERATED BY VEHICLE AND EQUIPMENT WASHING. ENGINE DEGREASING IS NOT ALLOWED ON THE SITE.
- PROVIDE EFFECTIVE CONTAINMENT FOR ALL LIQUID AND SOLID WASTES GENERATED BY WASHOUT OF CONCRETE, STUCCO, PAINT, FORM RELEASE OILS, CURING COMPOUNDS AND OTHER CONSTRUCTION MATERIALS. LIQUID AND SOLID WASHOUT WASTES MUST NOT CONTACT THE GROUND. DESIGN THE CONTAINMENT SO THAT IT DOES NOT RESULT IN RUNOFF FROM THE WASHOUT OPERATIONS OR CONTAINMENT AREA.
- CREATE AND FOLLOW A WRITTEN DISPOSAL PLAN FOR ALL WASTE MATERIALS. INCLUDE IN THE PLAN HOW THE MATERIAL WILL BE DISPOSED OF AND THE LOCATION OF THE DISPOSAL SITE. SUBMIT PLAN TO THE ENGINEER.
- 10. USE METHODS AND OPERATIONAL PROCEDURES THAT PREVENT DISCHARGE OR PLACEMENT OF BITUMINOUS GRINDINGS, CUTTING, MILLINGS, AND OTHER BITUMINOUS WASTES FROM AREAS OF EXISTING OR FUTURE VEGETATED SOILS AND FROM ALL WATER CONVEYANCE SYSTEMS, INCLUDING INLETS, DITCHES AND CURB FLOW LINES.
- 11. USE METHODS AND OPERATIONAL PROCEDURES THAT PREVENT CONCRETE DUST, PARTICLES, CONCRETE WASH OUT, AND OTHER CONCRETE WASTES FROM LEAVING SITE, DEPOSITING IN EXISTING OR FUTURE VEGETATED AREAS, AND FROM ENTERING STORMWATER CONVEYANCE SYSTEMS, INCLUDING INLETS, DITCHES AND CURB FLOW LINES, USE METHODS AND OPERATIONAL PROCEDURES THAT PREVENT SAW CUT SLURRY AND PLANING WASTE FROM LEAVING SITE AND FROM ENTERING STORMWATER CONVEYANCE SYSTEMS INCLUDING DITCHES AND CULVERTS.

## RECORD RETENTION

THE SWPPP. ALL CHANGES TO IT AND INSPECTION AND MAINTENANCE RECORDS MUST BE KEPT ON-SITE DURING CONSTRUCTION. THE OWNER MUST RETAIN A COPY OF THE SWPPP ALONG WITH THE FOLLOWING RECORDS FOR THREE (3) YEARS AFTER SUBMITTAL OF THE NOTICE OF TERMINATION (NOT):

- 1. ANY OTHER PERMITS REQUIRED FOR THE PROJECT
- RECORDS OF ALL INSPECTION AND MAINTENANCE CONDUCTED DURING CONSTRUCTION
- ALL PERMANENT OPERATIONS AND MAINTENANCE AGREEMENTS THAT HAVE BEEN IMPLEMENTED INCLUDING ALL RIGHT OF WAY, CONTRACTS, COVENANTS AND OTHER BINDING REQUIREMENTS REGARDING PERPETUAL MAINTENANCE: AND
- 4. ALL REQUIRED CALCULATIONS FOR DESIGN OF THE TEMPORARY AND PERMANENT STORMWATER MANAGEMENT SYSTEMS.

## SWPPP SCHEDULE OF INSTALLATION & MAINTENANCE

ITEM	INSTALLATION	INSPECTION & MAINTENANCE	REMOVAL
SILT FENCE	PRIOR TO COMMENCEMENT OF EARTHWORK OPERATIONS.	INSPECT & MAINT. AFTER EACH RUN-OFF EVENT. REMOVE SEDIMENTS AS REQUIRED.	AFTER TRIBUTARY DRAINAGE AREA IS RESTORED.
ROCK CONST. ENTRANCE	PRIOR TO COMMENCEMENT OF EARTHWORK OPERATIONS.	INSPECT REGULARLY. MAINTAIN AS NEEDED.	PRIOR TO PAVING.
OUTLET SKIMMER STRUCTURE	AFTER POND GRADING IS COMPLETED.	INSPECT REGULARLY. MAINTAIN AS NEEDED.	PERMANENT.
RIP-RAP & FILTER	UPON COMPLETION OF POND GRADING, CONC. SWALE CONST. AND OUTLET INSTALLATION.	INSPECT & MAINTAIN AT LEAST ANNUALLY AND AFTER HEAVY RAINFALL EVENT.	PERMANENT.
DETENTION POND	DURING EARTHWORK OPERATIONS.	AFTER HEAVY RAINFALL EVENTS. REMOVE SEDIMENTS AS NEEDED.	PERMANENT.
SEED & MULCH	AFTER POND GRADING IS COMPLETED.	INSPECT & MAINTAIN AFTER HEAVY RAINS. REPLACE WASH-OUT AREAS IMMEDIATELY	NO REMOVAL NECESSARY.
INLET PROTECTION	UPON INLET CONSTRUCTING	WHEN 1/3 CAPACITY OF BMP IS REACHED	AFTER TRIBUTARY AREAS ARE FULLY RESTORED

#### DESCRIPTION OF PERMANENT STORMWATER TREATMENT SYSTEMS

THE PROPOSED STORMWATER POND WILL HAVE A IRON-ENHANCED SAND FILTER FOR PRETREATMENT. DETAILS AND CALCULATIONS FOR THIS SYSTEM CAN BE FOUND IN THE STORMWATER REPORT.

#### **ESTIMATED BMPS QUANTITIES**

BMP	ORIGINAL ESTIMATE	MODIFICATION	DATE
ENERGY DISSIPATER			
TEMP. DIVERSION DIKES			
CHECK DAMS			
TEMP SEEDING			
PERMANENT SEEDING			
PERMANENT SODDING	141,166 SF		
MULCHES (SPECIFY TYPES)			
CAT 3 EROSION CONTROL BLANKET			
SOIL TACKIFIERS			
SILT FENCING	1,971 LF		
EROSION CONTROL MATS			
STORM DRAIN INLET PROTECTION	5 EACH		
TEMPORARY OR PERMANENT SEDIMENTATION BASINS			
CONSTRUCTION ENTRANCE	1 EACH		
DEWATERING (TREATMENT LOCATION, SCHEMATIC, & SAMPLING PLAN REQUIRED			
CONCRETE TRUCK WASHOUT			



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## THE VILLAGE AT COLOGNE **18TH ADDITION**

COLOGNE, MN 55322

**RON OLSON** 

PROFESSIONAL ENGINEER UNDER THE LAWS OF THE STATE

PRINT NAME: LEE KOPPY, PE

NOT FOR CONSTRUCTION

DATE: 7/3/2025 LICENSE NO. 41267

REVISION LOG

NO.	DESCRIPTION OF REVISIONS

PRELIMINARY PLAT 7/3/2025

DESIGNED: DRAWN: CHECKED BY: CDN


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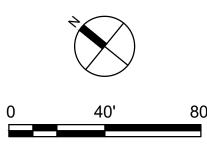
STORMWATER **POLLUTION PREVENTION** PLAN

DRAWING NO.


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JULY 3, 2025



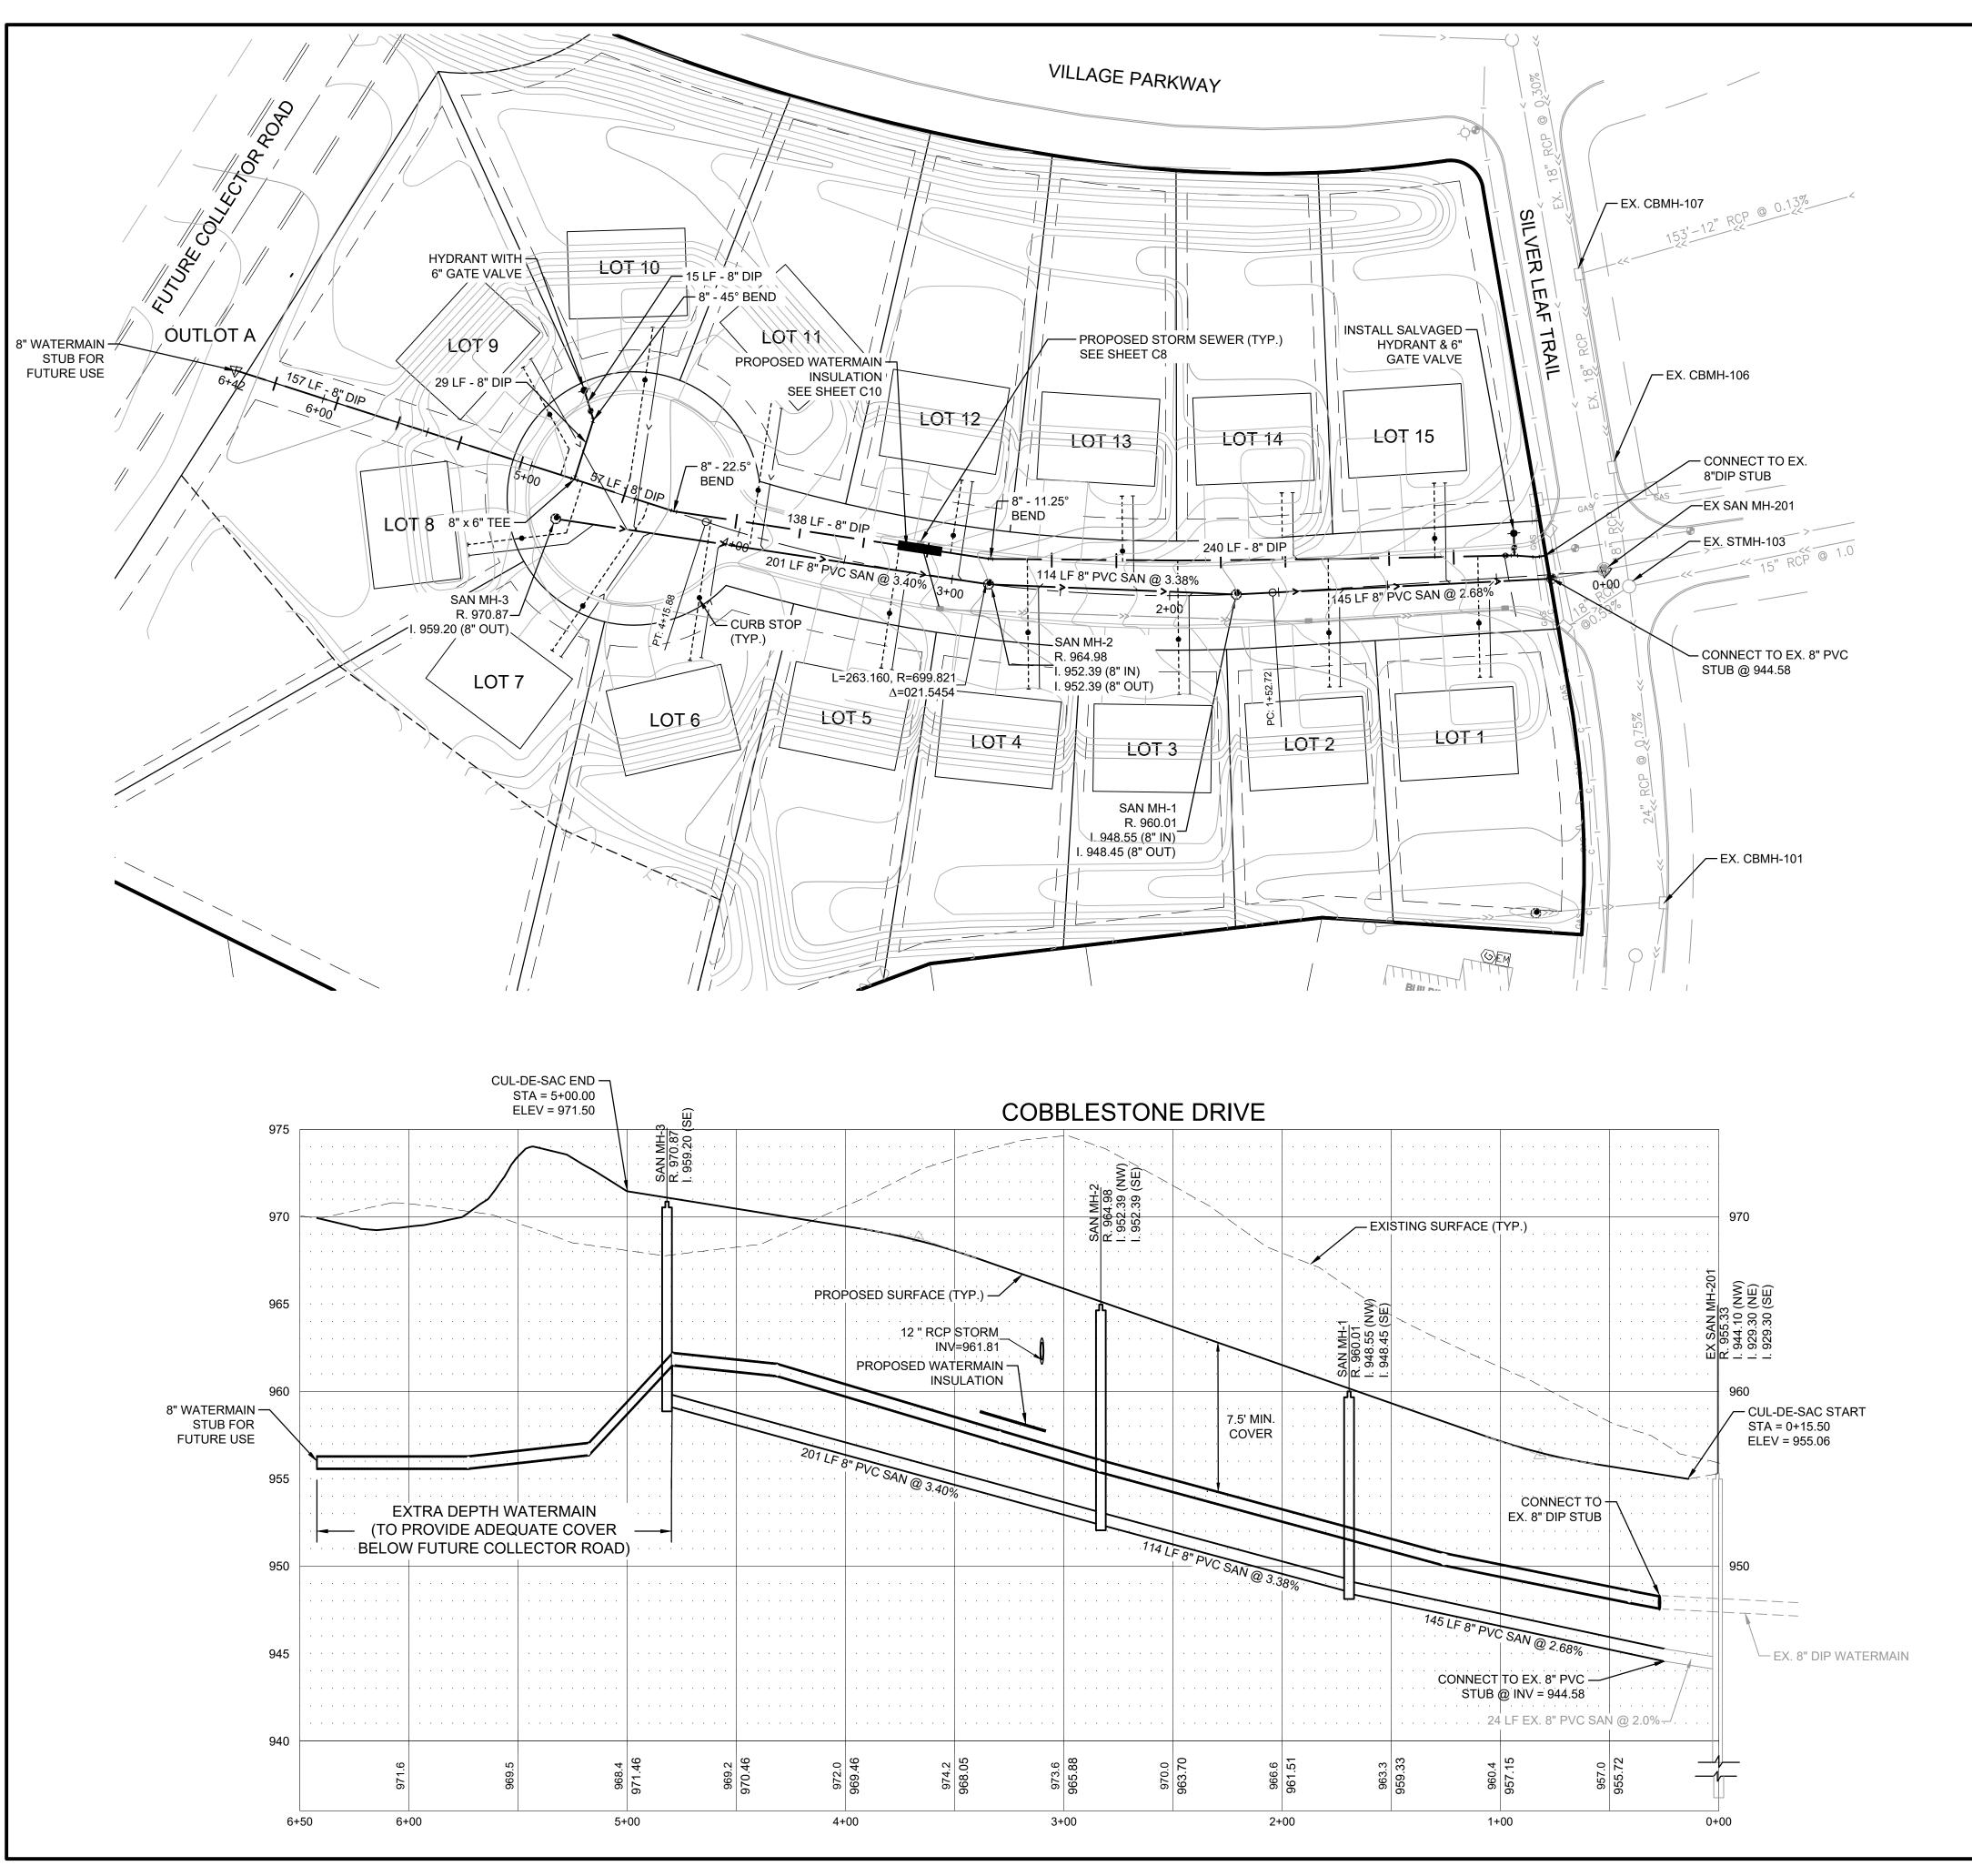

## LEGEND

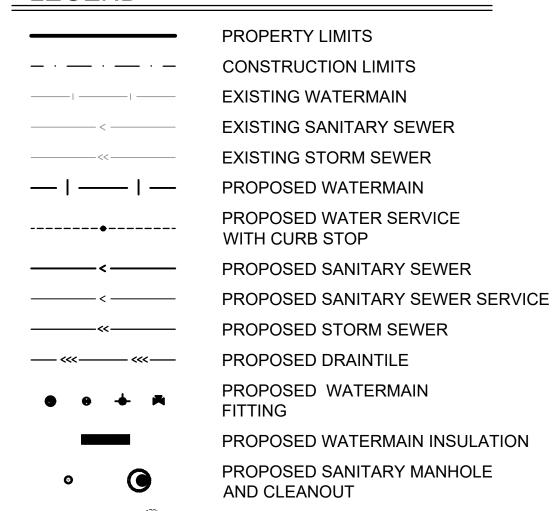

## **UTILITY NOTES**

1. ALL WATERMAIN TO BE INSTALLED WITH 7.5' MINIMUM COVER.

PROPOSED STORM INLETS

- 2. PROVIDE 10.0' MINIMUM HORIZONTAL SEPARATION BETWEEN SANITARY SEWER AND WATERMAIN.
- 3. WATERMAIN DISTANCES ARE MEASURED BETWEEN FITTINGS (BENDS, TEES, PLUGS).
- 4. THE CONTRACTOR IS REQUIRED TO ADHERE TO THE SPECIFICATIONS AND REGULATIONS SET FORTH BY THE CITY/UTILITY PROVIDER, CEAM, AND MINNESOTA PLUMBING CODE (MINNESOTA RULES CHAPTER 4714) CONCERNING THE MATERIALS, INSTALLATION, AND TESTING OF WATER AND SANITARY UTILITIES. VERIFY RECEIPT OF ALL REQUIRED PERMITS PRIOR TO CONSTRUCTION.

## MN DOLI NOTES

- 1. ALL PLUMBING SHALL BE INSTALLED IN ACCORDANCE WITH THE 2020 MINNESOTA PLUMBING CODE, CHAPTER 4714. ALL PIPE, PIPE FITTINGS, TRAPS, FIXTURES, MATERIAL, AND DEVICES IN THE PLUMBING SYSTEM SHALL MEET THEIR RELEVANT CODE SECTION REQUIREMENTS:
- 1.1. BE LISTED OR LABELED (THIRD PARTY CERTIFIED) BY A LISTING AGENCY.
- 1.2. COMPLY WITH THE APPROVED RECOGNIZED STANDARDS REFERENCED IN THE 2020 MINNESOTA PLUMBING CODE.
- 1.3. BE FREE OF DEFECTS.
- 2. PVC SANITARY SEWERS MUST MEET ASTM D1785, D2665, D3034, F794 F891, F949, DR1488 WITH APPROVED FITTINGS. SOLVENT WELDED JOINTS MUST USE ASTM F656 PURPLE PRIMER AND ASTM D2564 CEMENT. THE SEWER MUST BE INSTALLED BY OPEN TRENCH ON A CONTINUOUS GRANULAR BED PER ASTM D2321.
- 3. PE AND HDPE WATER SERVICES MUST MEET ASTM D2239, ASTM D2737, ASTM D3035, AWWA C901, OR CSA B137.1. INSTALLED PER THE MANUFACTURER'S INSTRUCTIONS (SEE 2020 MN PLUMBING CODE TABLE 604.1, SECTION 605.7, AND INSTALLATION STANDARD 7). JOINTS MUST BE HEAT FUSED OR USE APPROVED INSERT FITTINGS WITH STAINLESS STEEL.
- 4. STORM SEWERS WITHIN 10 FEET OF THE BUILDING OR WATER SERVICE MUST BE TESTED PER 2020 MN PLUMBING CODE SECTION 1109.0.
- HDPE STORM AND SANITARY SEWERS MUST MEET ASTM F714. WHEN APPROVED FOR USE AS A STORM OR SANITARY SEWER MATERIAL. INSTALLATION OF HDPE MUST MEET THE FOLLOWING REQUIREMENTS.
- 5.1. WATER TIGHT JOINTS MUST BE USED AT ALL CONNECTIONS, INCLUDING STRUCTURES.
- 5.2. INSTALLATION MUST BE BY OPEN TRENCH ON A CONTINUOUS GRANULAR BED PER ASTM D2321.
- THE CONNECTION BETWEEN HDPE TO A BUILDING SEWER OF DIFFERENT MATERIAL MUST BE MADE THROUGH AN APPROVED TRANSITION COUPLING FOR THE INTENDED MATERIALS.



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## THE VILLAGE AT COLOGNE 18TH ADDITION

COLOGNE, MN 55322

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PRINT NAME: LEE KOPPY, PE

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DATE: <u>7/3/2025</u> LICENSE NO. <u>41267</u>

REVISION LOG


DESCRIPTION OF REVISIONS

## PRELIMINARY PLAT

7/3/2025

DESIGNED: DRAWN: CHECKED BY:
LRK MAM LRK


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UTILITY PLAN

DRAWING NO.

**C7** 

PLOTTED: COMM. NO. JULY 3, 2025 18344



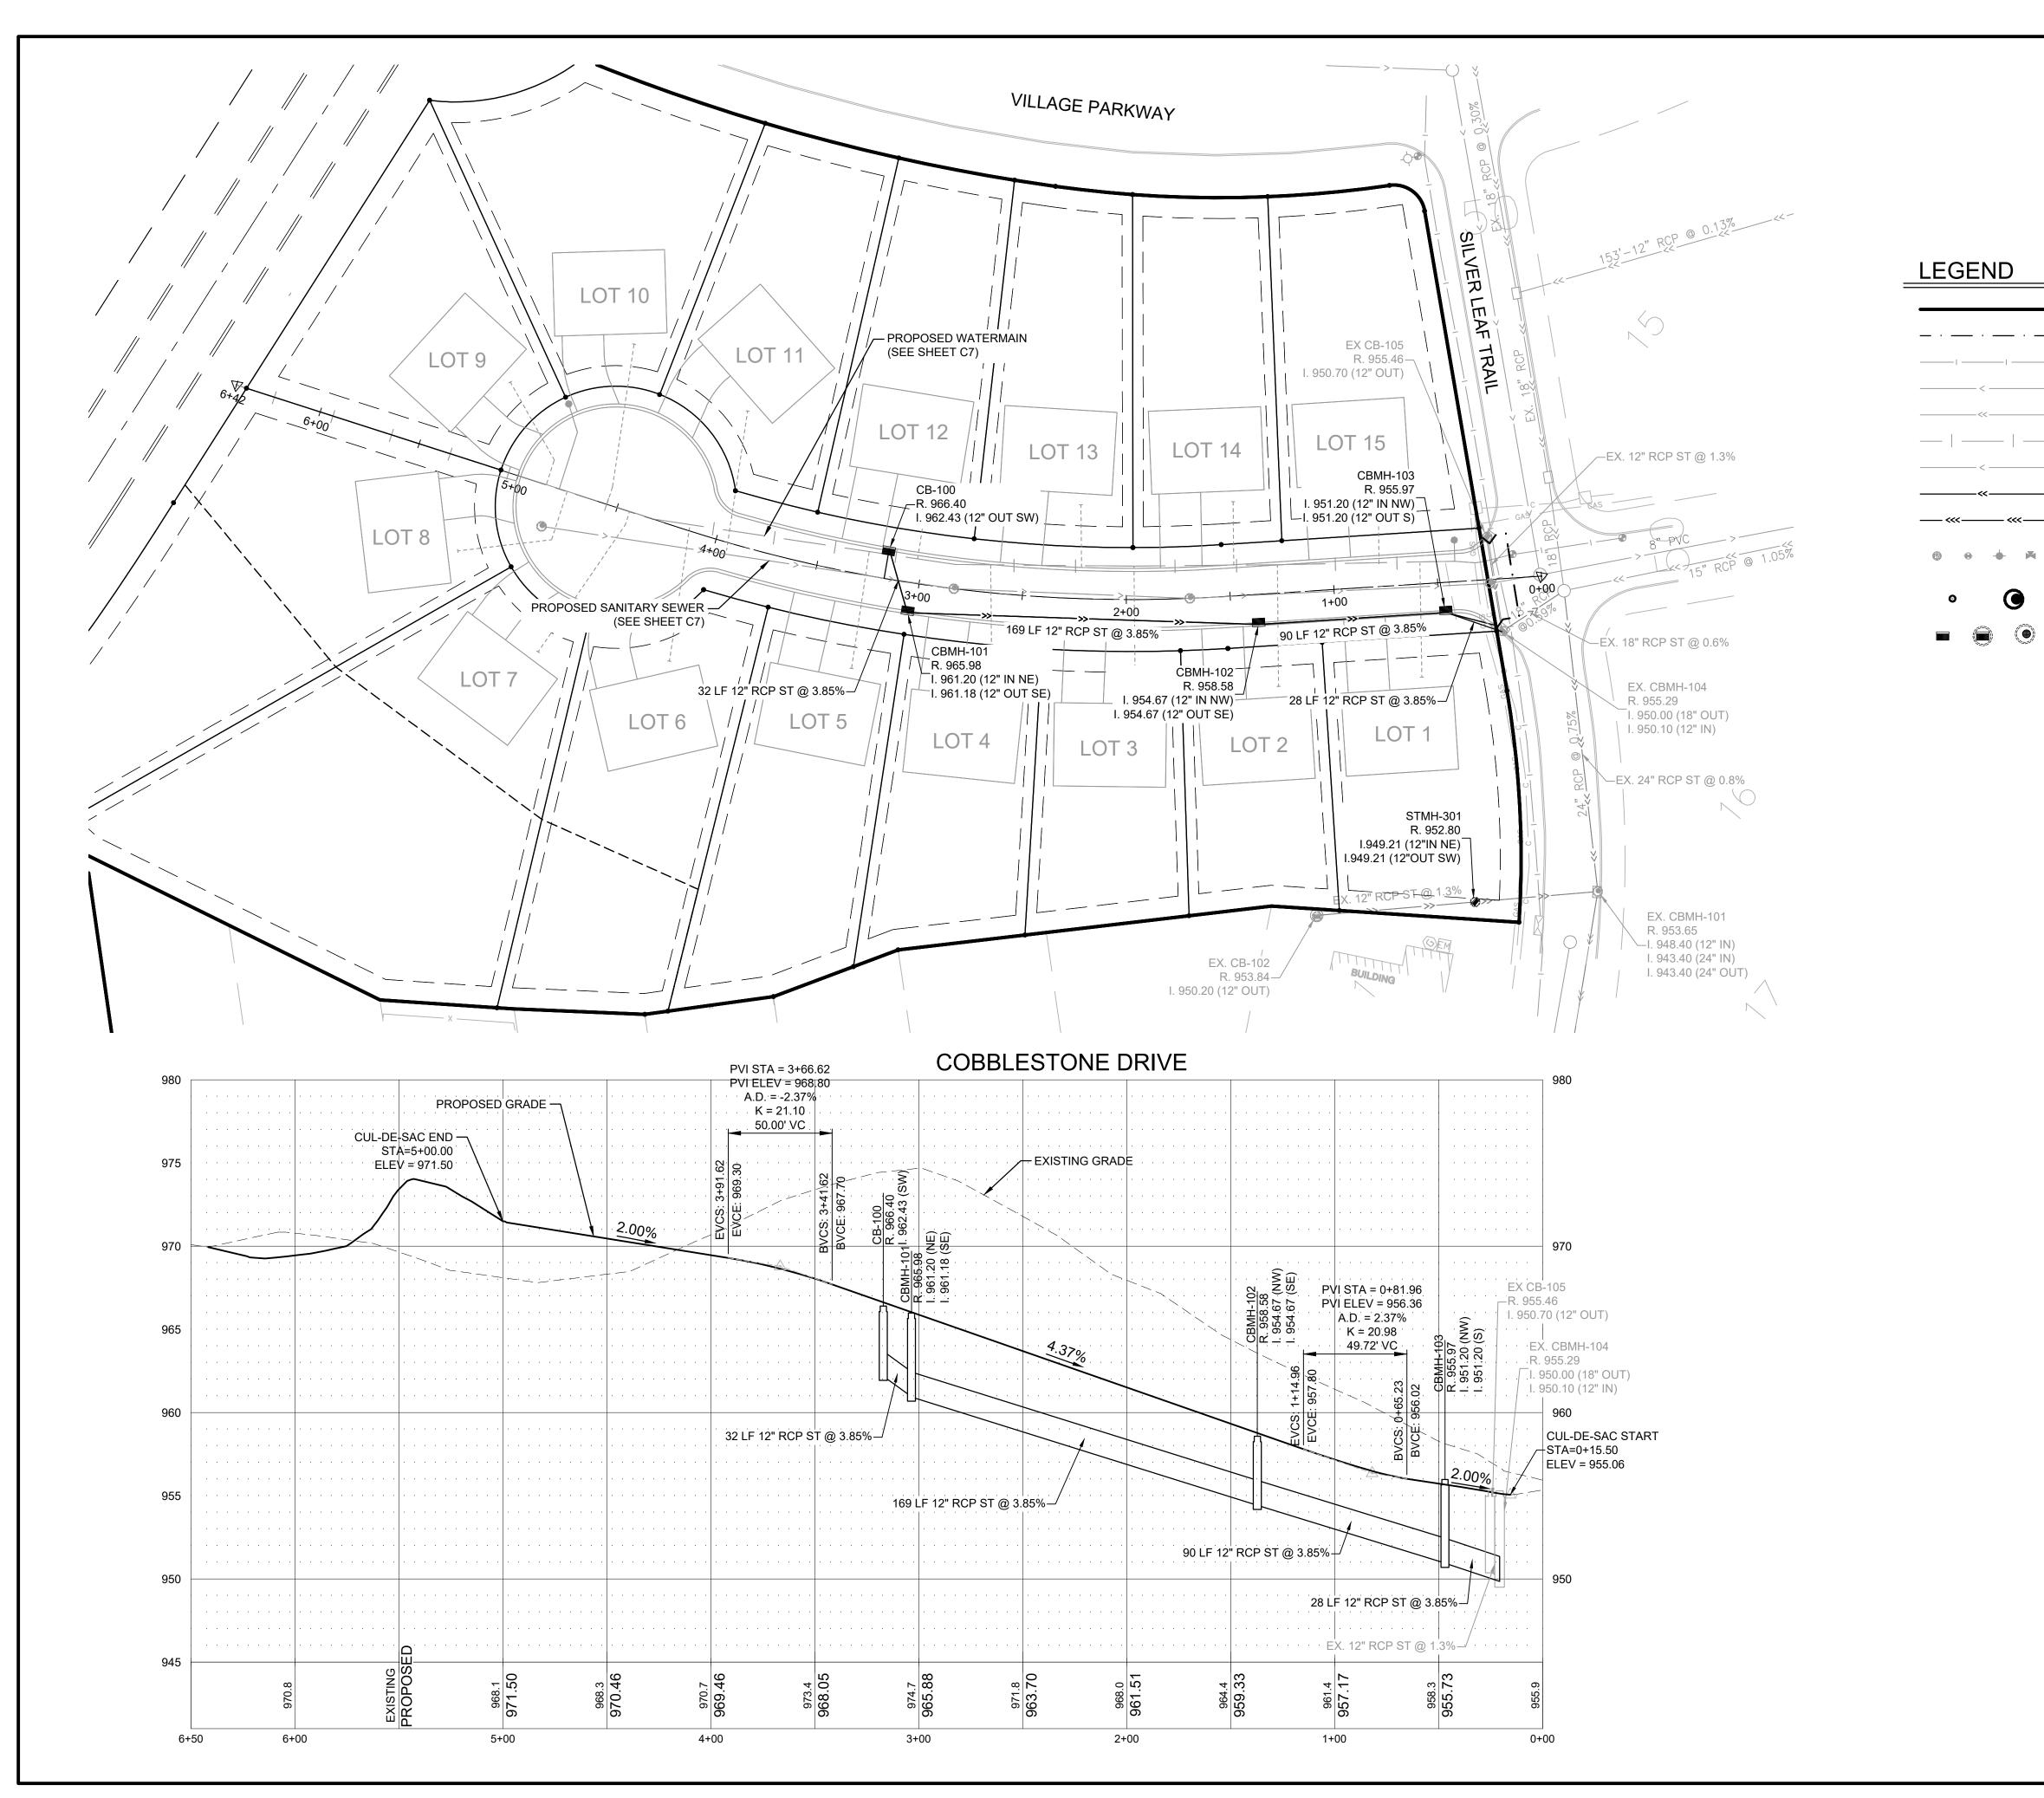

PROPERTY LIMITS

CONSTRUCTION LIMITS

**EXISTING WATERMAIN** 

**EXISTING SANITARY SEWER** 

PROPOSED SANITARY SEWER

PROPOSED SANITARY MANHOLE

PROPOSED STORM SEWER

PROPOSED DRAINTILE

FITTING

AND CLEANOUT

PROPOSED WATERMAIN

PROPOSED STORM INLETS

**EXISTING STORM SEWER** 

PROPOSED WATERMAIN

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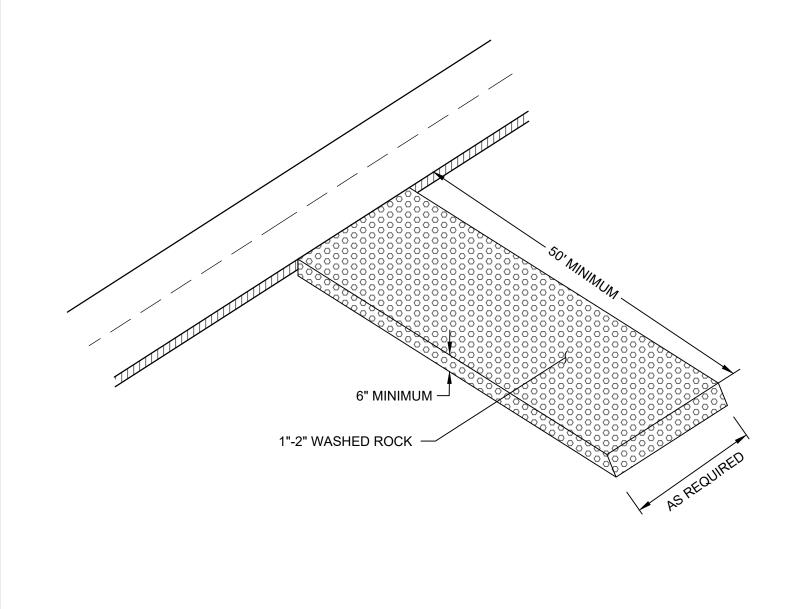
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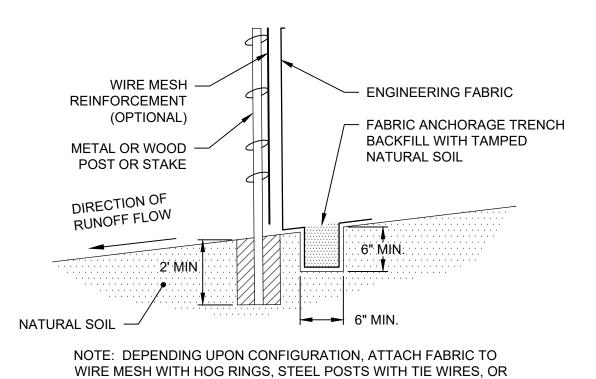
STREET &
STORM
SEWER PLAN

DRAWING NO.


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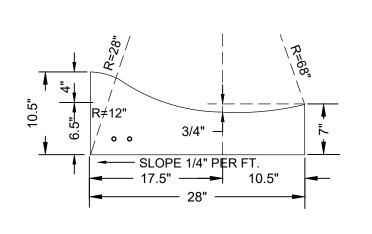
PLOTTED: JULY 3, 2025





3) FLEXIBLE SLEEVE DIMENSIONS SHALL CONFORM TO PRODUCERS



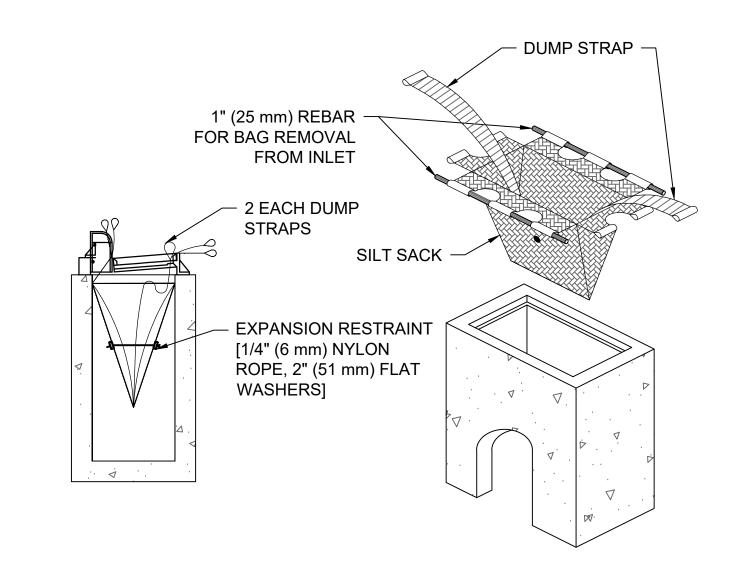

ROCK CONSTRUCTION ENTRANCE

SILT FENCE

WOOD POSTS WITH STAPLES.

**INLET SEDIMENT PROTECTION** 

MOUNTABLE CURB AND GUTTER

SCALE:NOT TO SCALE

CASTING SHALL BE NEENAH R-1642 WITH TYPE "C" COVER OR APPROVED EQUAL. SEE SPECIFICATION FOR CASTING ADJUSTMENT PROCEDURE IN ROADWAY BRING GROUND ELEVATION TO TOP OF CASTING OR AS DIRECTED BY THE ENGINEER. PRECAST CONCRETE ADJUSTING RINGS. RINGS SHALL BE SET IN A FULL MORTAR BED AND GROUTED ON THE OUTSIDE ONLY PRIOR TO BACK FILLING. NO GROUT SHALL BE PLACED ON THE INSIDE FACE OF RINGS. MAXIMUM OF 12" (RINGS AND MORTAR) BETWEEN BOTTOM OF CASTING AND TOP OF CONE SECTION. PRECAST REINFORCED CONCRETE MANHOLE, ASTM 16" O.C. SEE JOINT DETAIL - BOTTOM RISER WITH 6" INTEGRAL BASE MANHOLE STEPS MANHOLE NOTES: 1) MANHOLES WILL BE INSTALLED WITH BELL END FACING UP FOR 2) REINFORCING SHALL BE A MINIMUM OF A SINGLE LINE WIRE FABRIC HAVING AN AREA OF NOT LESS THAN 0.12 SQUARE INCHES PER FOOT OF **SLEEVE NOTES:** INTERNAL EXPANDING LOCKING BAND -(NON-CORROSION RESISTANT STEEL) 1) SHIM OR ADAPTER FOR "NON-STANDARD" PIPE ALLOWABLE. 2) FLEXIBLE SLEEVE SHALL BE A NEOPRENE MATERIAL MEETING THE REQUIREMENTS OF ASTM C-443 OR THE FOLLOWING ELASTOMER EPOM: OR TENSILE STRENGTH 1500 P.S.I. MIN. (DIE C. ASTM D 412 ELONGATION OF RUPTURE 450% MIN. (DIE C. SATM D 412) COMPRESSION SET 25% MAX. (22 HRS. @ 70 C. ASTM D 395, METHOD B DUROMETER 50 ± 5 (ASST. D 2240)

STANDARDS.

POSITIVE MECHANICAL

SEAL

ADJUST CASTING TO 1/2" MANHOLE FRAME AND COVER NEENAH R-1642-B BELOW FINISHED GRADE. WITH MACHINED BEARING SURFACE WITH 2 CONCEALED PICK HOLES OR APPROVED EQUAL. 2" ADJUSTING RINGS AS — - FULL BED OF MORTAR REQUIRED (MIN. 2, MAX. 4). BETWEEN RINGS CASTING AND ON OUTSIDE OF RINGS. 1. MANHOLES 8' DEEP OR GREATER, THE PRECAST SECTION IMMEDIATELY FOLLOWING THE CONE SECTION SHALL BE 1'-4" (16") STEPS 16" IN HEIGHT O.C. ON \_\_DOWNSTREAM 2. PROVIDE STEPS IN ALL SIDE MANHOLES OVER 4.5 FEET IN "O" RING GASKETS BETWEEN EACH JOINT IN MAN HOLE SECTIONS. \*48" DIAMETER WHEN PIPE IS 36" OR SMALLER. 72" DIAMETER WHEN PIPE IS LARGER THAN 36". SEE STRUCTURE SCHEDULE **USE T-SECTION MANHOLE** FLOW WHERE POSSIBLE (DESIGN J) WITH OFFSET CONE CONNECTION OR PRECAST SLAB. BASE: PRECAST OR POURED-IN-PLACE CONCRETE MINIMUM SLAB THICKNESS 6" FOR 14' DEPTH. INCREASE THICKNESS 1" FOR EACH 4' OF DEPTH GREATER THAN 14' AND REINFORCE WITH 6"X6" 10/10

BITUMINOUS CONCRETE WEAR COURSE BITUMINOUS CONCRETE BASE COURSE — BITUMINOUS TACK COAT — BITUMINOUS BINDER PG 58-28 - SAWCUT PAVEMENT FULL DEPTH FLUSH W/ADJACENT PAVEMENT — EX. PAVEMENT WOVEN GEOTEXTILE FABRIC FOR SUBGRADE STABILIZATION AGGREGATE SUBBASE, CONFORMING TO 3/4 INCH OR 1 1/4 INCH DENSE GRADED BASE APPROVED SUBGRADE BY OWNER'S INDEPENDENT TESTING AGENCY. EXISTING SUBGRADE

SANITARY MANHOLE SCALE: NOT TO SCALE

INTEGRALLY CAST

SLEEVE SEAL

STORMWATER MANHOLE

BITUMINOUS PAVEMENT SECTION SCALE: NOT TO SCALE

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REVISION LOG

DESCRIPTION OF REVISIONS

PRELIMINARY PLAT 7/3/2025

DESIGNED: DRAWN: CHECKED BY: LRK CDN LRK


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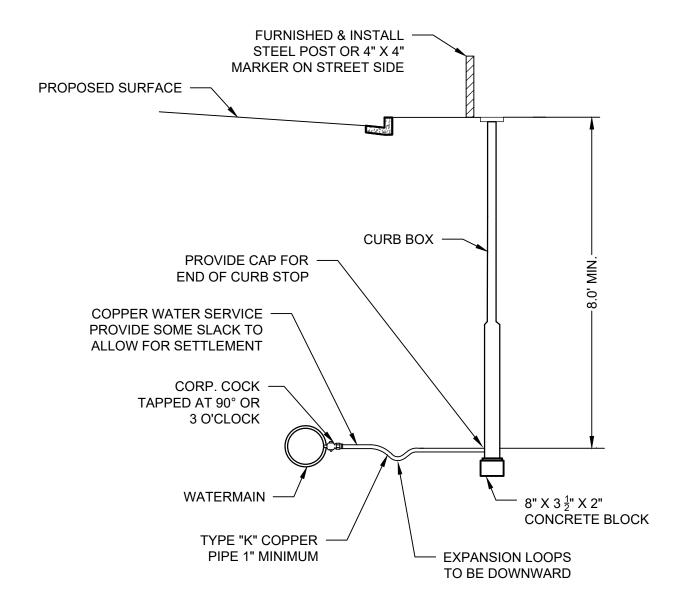
COMM. NO. 18344

PLOTTED: JULY 3, 2025



HYDRA-FINDER — (RED & WHITE) HYDRANT TO BE 5' MIN HYDRANT TO BE FACTORY PAINTED RED FROM BACK OF CURB **HYDRANT- WATEROUS** PACER WB67 FINISHED GRADE STANDPIPE ----GATE VALVE BOX MINIMUM 2 LAYERS TAR PAPER OR 6" WATERMAIN -MEGALUG RESTRAINT POLYETHLENE (OR EQUIVALENT) TYPICAL ALL JOINTS TEE -1 CU. YD — CRUSHED ROCK - 6" GATE VALVE └─ 6" PVC CONCRETE THRUST -**BLOCK AND BASE**  CONCRETE BLOCK 3/4" TIE RODS  $\stackrel{\wedge}{-}$ (GALVANIZED)

CURB BOXES INSTALLED IN AREAS WHERE BOULEVARD IS TO BE CUT AT A LATER DATE SHALL BE INSTALLED AT DEPTH REQUIRED. CURB BOX EXTENSION FOR BOXES EXCEEDING 7.5' IN LENGTH ARE TO BE BID AT CONTRACT UNIT PRICE AND SHALL INCLUDE STACK COUPLINGS, CONNECTIONS, ETC.

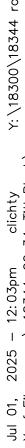

TYPICAL WATER SERVICE CONNECTION SCALE:NTS

WATERMAIN INSULATION

HYDRANT & GATE VALVE INSTALLATION

SCALE:NTS


GROUT, WITH AN APPROVED BONDING AGENT ADDITIVE, SHALL BE PLACED BETWEEN AND OUTSIDE OF THE ADJUSTING RINGS. PROPOSED SURFACE — MANHOLE CASTING NEENAH R-2394 TYPE C GRATE OR EQUAL. - 3 MIL POLYETHLENE WRAP AROUND THE OUTSIDE OF THE CONC. ADJUSTING RINGS 2" ADJUSTING RINGS -MIN. - 2 MAX. - 6 - CONC. MIX SHALL INCORPORATE THE ENTIRE CASTING AND ADJUSTING RINGS. REINFORCED -ONLY <u>CONCRETE</u> OR <u>METAL</u> CONC. PIPE GROUT BENCH SHIMS SHALL BE USED FOR & FLOW LINE LEVELING CASTING. POURED OR PRECAST CONC. BASE


PROPOSED SURFACE

(SEE GRADING PLAN)

STYROFOAM INSULATION

WATER SERVICE PIPE

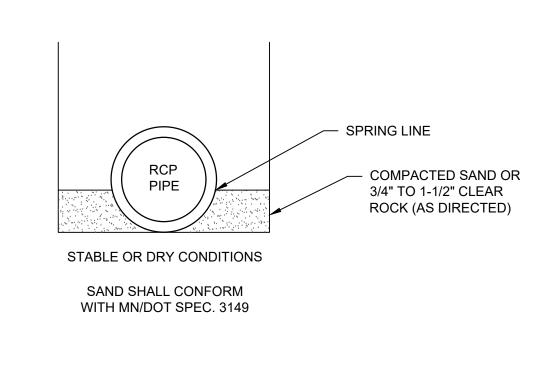

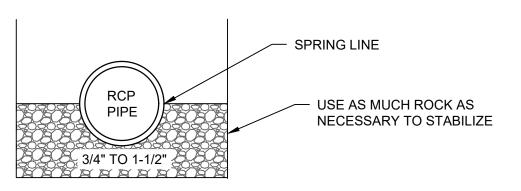

UNSTABLE OR WET CONDITIONS

STORM CATCH BASIN SCALE: NOT TO SCALE

STORM SEWER BEDDING

SCALE: NOT TO SCALE

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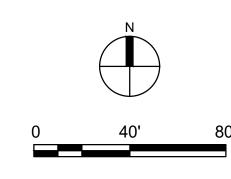
CIVIL DETAILS

DRAWING NO.

C10

JULY 3, 2025





# PROPERTY LIMITS - · - · - · - CONSTRUCTION LIMITS - · 966 - EXISTING MINOR CONTOUR - 965 - EXISTING MAJOR CONTOUR PROPOSED MINOR CONTOUR PROPOSED MINOR CONTOUR PROPOSED MAJOR CONTOUR

SOD

**EXISTING WOODLAND PERIMETER** 

## NOTES

- 1. PER CITY OF COLOGNE, IRRIGATION IS NOT REQUIRED.
- 2. IF A DISCREPANCY IS FOUND, THE PLANTING PLAN SHALL OVERRIDE THE PLANT SCHEDULE.
- 3. SEE CIVIL FOR EROSION CONTROL BLANKET LOCATIONS.

## PLANT SCHEDULE

_	SYMBOL	CODE	<u>QTY</u>	COMMON / BOTANICAL NAME	<u>CONT</u>	CAL	
	DECIDUOUS TREES						
_		Aa	3	AUTUMN BLAZE® FREEMAN MAPLE ACER X FREEMANII 'JEFFERSRED'	B&B	2 - 1/2" CAL	
		Gi	5	SKYLINE® HONEY LOCUST GLEDITSIA TRIACANTHOS INERMIS 'SKYCOLE'	B&B	2 - 1/2" CAL.	
`	£ .	Tb	4	BOULEVARD AMERICAN LINDEN TILIA AMERICANA 'BOULEVARD'	B&B	2 - 1/2" CAL.	
	EVERGRE	EN TREE	<u>:S</u>				
	000000000000000000000000000000000000000	Pb	6	BLACK HILLS SPRUCE PICEA GLAUCA DENSATA	B&B	6` HT.	

## GENERAL SODDING & TOPSOIL NOTES:

- . LANDSCAPE CONTRACTOR SHALL ENSURE THAT NEW TREES MOVED ONTO THE SITE ARE DUG FROM SIMILAR SITES WITH SIMILAR SOILS TO THE SOILS OF THIS PROJECT (HEAVY TO HEAVY, LIGHT TO LIGHT. HEAVY TO LIGHT SOILS). CONTRACTOR SHALL REVIEW SOIL CONDITIONS/TYPES WITH OWNER/LANDSCAPE ARCHITECT PRIOR TO INSTALLATION.
- ALL NEWLY INSTALLED PLANT MATERIAL SHALL BE PLANTED IN WELL-DRAINED AREAS. NOTIFY THE LANDSCAPE ARCHITECT PRIOR TO INSTALLATION IF ANY PLANT MATERIAL IS LOCATED IN DRAINAGE SWALES OR WET & POORLY DRAINED AREAS.
- 3. ALL PLANTINGS SHALL RECEIVE FERTILIZER AS FOLLOWS:
- 3.1. SUMMER AND FALL PLANTING: 0-20-20 GRANULAR (IN SAUCER AROUND PLANT AT THE RATE OF 12 OZ. PER 2-3" CAL. TREE & 6 OZ. PER SHRUB).
- 3.2. SPRING PLANTING: 10-10-10 GRANULAR (APPLY ABOVE REFERENCED FERTILIZER AT A RATE OF 12 OZ. PER 1-1/2" CAL. TREE OR LARGER & 6 OZ. PER SHRUB & PERENNIAL.
- 4. ALL PLANTINGS SHALL RECEIVE AN AMENDED SOIL MIX CONSISTING OF THREE (3) PARTS:
- 4.1. 45% APPROVED TOPSOIL (ONE SITE PREFERRED)
- 4.2. 45% ORGANIC MATTER (TYPE 1 SPHAGNUM PEAT MOSS FINELY DIVIDED WITH A PH OF 3.1 5.0.)
- 4.3. 10% SAND (FINE CLEAN MASONRY SAND)
- 5. AREAS TO RECEIVE SOD SHALL HAVE A 6" MINIMUM DEPTH OF TOPSOIL.
  TOPSOIL SHALL PROVIDE FERTILE, FRIABLE, NATURAL LOAM, SURFACE SOIL,
  REASONABLY FREE OF SUBSOIL, CLAY CLUMPS, BRUSH WEEDS AND OTHER
  LITTER, AND FREE OF ROOTS, STUMPS, STONE LARGER THAN 1" IN ANY
  DIMENSION, AND OTHER EXTRANEOUS OR TOXIC MATTER HARMFUL TO PLANT
  GROWTH.
- SOD SHALL BE 30" X 100' ROLLS WHERE APPLICABLE, TO BE LAID PARALLEL WITH THE CONTOURS AND HAVE STAGGERED JOINTS. ON SLOPES STEEPER THAN 3:1 OR DRAINAGE SWALES, THE SOD SHALL BE STAKED INTO THE GROUND. SCARIFY THE EXISTING GRADES WITH FIELD CULTIVATOR PRIOR TO PLACING OF TOPSOIL AND FINISH GRADING FOR SOD. IMMEDIATELY PRIOR TO PLACING SOD, CONTRACTOR SHALL APPLY 10-6-4 FERTILIZER AT THE RATE OF 10 POUNDS PER 1000 SQ. FT.



13605 1st Avenue N. #100 Plymouth, MN 55441 | ae-mn.com P 763.412.4000 | F 763.412.4090 Anderson Engineering of Minnesota, LLC

## THE VILLAGE AT COLOGNE 18TH ADDITION

COLOGNE, MN 55322

**RON OLSON** 

I HEREBY CERTIFY THAT THIS PLAN, SPECIFICATION, OR REPORT WAS PREPARED BY ME OR UNDER MY DIRECT SUPERVISION AND THAT I AM A DULY LICENSED PROFESSIONAL ENGINEER UNDER THE LAWS OF THE STATE OF MINNESOTA

PRINT NAME: LEE KOPPY, PE

SIGNATURE: NOT FOR CONSTRUCTION

DATE: <u>7/3/2025</u> LICENSE NO. <u>41267</u>

REVISION LOG

DESCRIPTION OF REVISIONS

## PRELIMINARY PLAT

7/3/2025

DESIGNED: DRAWN: 0

ESIGNED: DRAWN: CHECKED BY:
LRK CDN LRK

DRAWING TITLE

LANDSCAPE PLAN

DRAWING NO.

L

PLOTTED: COMM. NO. JULY 3, 2025 18344